PLANNING AND DEVELOPMENT DEPARTMENT MEMORANDUM 13-31

DATE:

July 22nd, 2013

TO:

Honorable Mayor Joyce Downing and City Council Members

FROM:

David Willett, Acting City Manager

Brook Svoboda, Director of Planning and Development

SUBJECT:

CB-1806 - Rezoning for Certain Real Properties at 11525 Community

Center Drive -Stone Mountain II Preliminary PUD Amendment

BACKGROUND

Attached to this memo is a proposed ordinance, which if approved, would establish a an amendment to the existing Planned Unit Development (PUD) zoning of the parcel located at 11525 Community Center Drive Preliminary PUD. Staff presented the Preliminary and Final PUD application to the Planning Commission through a Public Hearing at the July 9th, 2013 Meeting. A copy of the Planning Commission Recommendation, Staff Report and PUD Application is included as Attachment 1-3.

As part of the PUD approval the following items will also be considered at the time of second reading of this ordinance (08/12/13):

- Final Subdivision Plat for Stone Mountain Filing #3
- Subdivision Improvement Agreement for public infrastructure associated with the project

PROCEDURE

The Planning Commission unanimously recommended approval, via Planning Commission Resolution 2013-08, the Stone Mountain II PUD based on five findings of fact:

- The proposed development is compatible with the surrounding area;
- The proposed development is not inconsistent with the City's Master Plan;
- The proposed development does not adversely affect the health, safety, and welfare of the inhabitants of the area and the City of Northglenn;
- Adequate circulation exists and traffic movement will not be impeded by the proposed development; and
- Additional municipal service costs will not be incurred.

Planning Commission Resolution 2013-08, also includes the following condition for final adoption by the Council:

1. The applicant shall enter into a Subdivision Improvement Agreement, with the City of Northglenn, that will be recorded with the Adam's County Clerk and Recorder's Office, to memorialize the public improvements shown in the PUD plans.

BUDGET/TIME IMPLICATIONS:

This ordinance amendment request has no budgetary impacts.

POTENTIAL OBJECTIONS:

No objections from the public were heard at the Planning Commission meeting

RECOMMENDATION

Staff recommends Council approve CB-1806

STAFF REFERENCE

Brook Svoboda, Director of Planning and Development bsvoboda@northglenn.org or 303.450.8937

ATTACHMENTS

ATTACHMENT 1 Planning Commission Resolution 2013-08

ATTACHMENT 2 Staff Report

ATTACHMENT 3 PUD Documents / Application

SPONSORED BY: MAYOR DOWNING

COUNC	ILMAN'S BILL	ORDINANCE NO.
No	CB-1806	
Serie	es of 2013	Series of 2013

A BILL FOR A SPECIAL ORDINANCE REZONING FROM PLANNED UNIT DEVELOPMENT (PUD), TO PLANNED UNIT DEVELOPMENT CERTAIN REAL PROPERTY IN THE CITY OF NORTHGLENN COMMONLY KNOWN AS THE "STONE MOUNTAIN 2" IN THE COUNTY OF ADAMS, STATE OF COLORADO, AND AMENDING THE ZONING MAP OF THE CITY OF NORTHGLENN

WHEREAS, all of the property described in **Exhibit A** is currently zoned PUD with a legal description as follows:

Lot 1 of Stone Mountain Subdivision Filing No. 2. Situated in the Southwest ¼ Section of Township 02 South, Range 68 West of the 6th P.M., City of Northglenn, County of Adams, State of Colorado.

WHEREAS, the City Council desires to rezone the property described in **Exhibit A** to PUD, pursuant to the Preliminary and Final PUD attached hereto as **Exhibit B**.

BE IT ORDAINED BY THE CITY COUNCIL OF THE CITY OF NORTHGLENN, COLORADO, THAT:

Section 1. Findings of Fact. The City Council hereby makes the following findings of fact:

- (a) The proposed development is compatible with the surrounding area;
- (b) The proposed development is not inconsistent with the City's Master Plan;
- (c) The proposed development does not adversely affect the health, safety, and welfare of the inhabitants of the area and the City of Northglenn;
- (d) Adequate circulation exists and traffic movement will not be impeded by the proposed development; and
- (e) Additional municipal service costs will not be incurred.
- Section 2. Rezoning. Pursuant to the provisions of the Northglenn Zoning Ordinance, as amended, and upon the recommendation of the Northglenn Planning Commission (Case No. Z-1-13), a zoning change to Planned Unit Development (PUD) is hereby allowed and granted for the real property in the City of Northglenn, Colorado described in the attached **Exhibit A**, pursuant to the Preliminary and Final PUD attached as **Exhibit B**.
- <u>Section 3</u>. <u>Change of Zone Maps</u>. The official zoning map of the City of Northglenn, pursuant to the provisions of Section 11-3-1 of the Municipal Code of the City of Northglenn, as

amended, and the Comprehensive Master Plan of the City of Northglenn shall be and hereby are ordered amended to conform with the provisions of this Ordinance.

<u>Section 4.</u> <u>Public Improvement Agreement Requirement.</u> The PUD shall not be recorded until the following conditions are satisfied:

- (a) The property shall be subdivided, and a Public Improvement Agreement entered into to cause the necessary public improvements to be constructed to serve the Property;
- (b) A Performance Guarantee shall be provided to secure construction of the necessary public improvements; and
- (c) The PUD shall be recorded concurrently with the Subdivision Plat and the Public Improvement Agreement.

<u>Section 5</u>. <u>Violations-Penalty</u>. Violations of the provisions of this Ordinance shall be punishable by a fine of not more than one thousand dollars (\$1,000.00), or by imprisonment for a period of not more than one (1) year, or both such fine and imprisonment.

INTRODUCED, READ AND 2013.	O ORDERED POSTED this day of
ATTEST:	JOYCE DOWNING Mayor
JOHANNA SMALL, CMC City Clerk	-
PASSED ON SECOND AND 2013.	FINAL READING this day of
	JOYCE DOWNING Mayor
ATTEST:	APPROVED AS TO FORM:
JOHANNA SMALL, CMC City Clerk	COREY Y. HOFFMANN City Attorney

EXHIBIT A

LEGAL DESCRIPTION

Lot 1 of Stone Mountain Subdivision Filing No. 2. Situated in the Southwest ¼ Section of Township 02 South, Range 68 West of the 6th P.M., City of Northglenn, County of Adams, State of Colorado.

LEGAL DESCRIPTION:

STONE MOUNTAIN SUBDIVISION, FILING NO. 2, AS PER THE PLAT RECORDED APRIL 22, 2002 AT RECEPTION NO. C0959033, AND ALSO RECORDED JANUARY 7, 2003 AT RECEPTION NO. C1077063. COUNTY OF ADAMS. STATE OF COLORADO.

BENCHMARK:

ELEVATIONS ARE BASED ON NATIONAL GEODETIC SURVEY CONTROL POINT "S 411" LOCATED NAVD 88 ELEVATION IS 5285.50'. THE SITE BENCHMARK IS A #5 REBAR, 18" LONG WITH 1-1/4" GREEN PLASTIC CAP STAMPED "CONTROL POINT" NAVD 88 ELEVATION =5423.78. LOCATED 47' EAST OF THE NORTHEAST CORNER OF THE SITE, AS SHOWN HEREON

BASIS OF BEARINGS:

BEARINGS ARE BASED ON THE NORTH LINE LOT 1, STONE MOUNTAIN SUBDIVISION, FILING NO. 2, AS MONUMENTED BY NUMBER 5 REBARS WITH 1-1/4" YELLOW PLASTIC CAPS, PLS 10945 AT BOTH ENDS AS BEARING S87°06'40"W AS SHOWN ON STONE MOUNTAIN SUBDIVISION, FILING NO. 2.

CONSTRUCTION SCHEDULE:

IT IS ANTICIPATED THAT CONSTRUCTION WILL START IN THE MIDDLE OF 2013, AND BE COMPLETED

THE CITY OF NORTHGLENN RESERVES THE RIGHT TO PERIODICALLY REVIEW THIS P.U.D. FOR CONFORMANCE WITH ITS PROPOSED CONSTRUCTION SCHEDULE AND, WHEN APPROPRIATE, REZONE THIS PROPERTY TO A DIFFERENT ZONING CLASSIFICATION.

LANDUSE:

ALL USES ALLOWED IN ANY RESIDENTIAL R-3 ZONE DISTRICT OF THE CITY OF NORTHGLENN.

ENGINEER CERTIFICATION

I HEREBY CERTIFY THAT THESE PLANNED UNIT DEVELOPMENT (P.U.D.) DOCUMENTS FOR **STONE** MOUNTAIN - PHASE II WERE PREPARED BY ME (OR UNDER MY DIRECT SUPERVISION) IN ACCORDANCE WITH THE CITY OF NORTHGLENN DESIGN AND CONSTRUCTION STANDARDS.

REGISTERED PROFESSIONAL ENGINEER STATE OF COLORADO NO. 43327

LAND USE SUMMARY			
LAND USE	PROPOSED		
SITE	1		
SITE AREA (GROSS):	392,230 SF / 9.00 AC		
DWELLING UNITS:	228 DU'S		
GARAGES:	13 DETACHED GARAGES		
DWELLING UNITS PER ACRE:	25.3 DU/AC		
BUILDING CODE:	2009 IBC		
OCCUPANCY CLASSIFICATION (APTS):	R2		
OCCUPANCY CLASSIFICATION (GARAGES):	U		
DEVELOPMENT PROPOSAL			
ALLOWED USES:	MULTI-FAMILY RESIDENTIAL		
LOT COVERAGE - BUILDING:	108,159 SF = 28%		
LOT COVERAGE - PAVING:	175,634 SF = 46%		
LOT COVERAGE - OPEN AREA:	101,103 SF = 26%		
LOT COVERAGE - TOTAL:	283,793 SF = 74%		
LANDSCAPE AREA:	101, 103 SF = 26%		
FRONT YARD SETBACK:	25 FT MIN		
SIDE YARD SETBACK:	15 FT MIN		
REAR YARD SETBACK (ACCESSORY BLDG):	5 FT MIN		
REAR YARD SETBACK (PRINCIPAL BLDG):	60 FT MIN		
MINIMUM LOT AREA PER UNIT:	1,720 FT MIN		
BUILDING HEIGHT:	42 FT		

I EM NO.	IIEM	QUANTITY	UNII	UNII COST	TOTAL COST
1	8" PVC WATER	1910	ĻF	\$55.00	\$105,050.00
2	1" WATER METER	1	EA	\$8,000.00	\$8,000.00
3	2" WATER METER	9	EA	\$12,500.00	\$112,500.00
4	6" DIP FIRE HYDRANT LINE	125	LF	\$85.00	\$10.625 00
5	FIRE HYDRANT ASSEMBLY	6	EA	\$5,500.00	\$33,000.00
6	4" GATE VALVE	9	EA	\$2,000.00	\$18,000.00
7	6" GATE VALVE	6	EA	\$2,500.00	\$15,000.00
8	8" GATE VALVE	10	EA	\$2,800.00	\$28,000.00
9	8"X4" TEE	9	EA	\$2,900.00	\$26,100.00
10	8"X6" TEE	6	EA	\$3,200.00	\$19,200 00
11	8"X8" TEE	3	EA	\$3,500.00	\$10,500.00
12	8" ~ 11.25-DEGREE BEND	11	EA	\$550.00	\$6,050.00
13	8" ~ 45-DEGREE BEND	11	EA	\$750.00	\$8,250.00
14	8" PVC SANITARY	1092	LF	\$40.00	\$43,680.00
15	4' INSIDE DIAMETER MANHOLE	8	EA.	\$4.500.00	\$36,000.00
		-		Ψ-1,000.00	\$20,000.00
17	18" RCP STORM SEWER	409	LF	\$69.00	\$28,221.00
18	24" RCP STORM SEWER	1422	LF	\$93.00	\$132,246 00
19	30" RCP STORM SEWER	127	LF	\$114.00	\$14,478.00
20	36" RCP STORM SEWER	104	LF	\$134.00	\$13,936.00
21	34" x 53" RCP STORM SEWER	76	LF	\$158.00	\$12,008.00
22	DETENTION POND QUILET STRUCTURE	1	EA	\$10,000.00	\$10,000.00
23	HEADWALL W/ ORIFICE PLATE	1	EA	\$3,000.00	\$3,000.00
24	INLET TYPE C	2	EA	\$3,000.00	\$6,000.00
25	INLET TYPE 13	1	EA	\$4,250.00	\$4,250.00
26	INLET MODIFIED DOUBLE TYPE 13	2	EA	\$8,500.00	\$17,000.00
27	INLET MODIFIED TRIPLE TYPE 13	1	EA	\$12,750.00	\$12,750.00
28	INLET TYPE R 5'	1	EA	\$4,000.00	\$4,000.00
29	5' INSIDE DIAMETER MANHOLE	10	EA	\$5,100.00	\$51,000.00
30	6' INSIDE DIAMETER MANHOLE	3	EA	\$5,900.00	\$17,700.00
-		-		45,500.00	Ţ,. 23.00
31	HANDICAP RAMPS	4	EA	\$1,250.00	\$5,000.00
32	6" CURB AND GUTTER	88	LF	\$4.00	\$352.00
33	8' CROSSPAN	1214	SF	\$8.00	\$9,712 00
34	SIDEWALK	675	SF	\$4.00	\$2,700.00
35	ASPHALT PAVING	300	SF	\$2.50	\$750.00
36	MODILIZATION/CENEDAL CONDITIONS	1	LS	\$5,000,00	95 000 00
30	MOBILIZATION/GENERAL CONDITIONS	1	LS	\$5,000.00	\$5,000.00
				SUBTOTAL	\$830,058.00
				15% CONTINGENCY	\$124,508.70
				TOTAL	\$954,566.70

STONE MOUNTAIN PHASE II APARTMENTS PUBLIC IMPROVEMENTS


OPINION OF PROBABLE CONSTRUCTION COST

	PARKING SUMMARY	
	REQUIRED PARKING (SECTION 11-33-6, ZONING ORDINANCE)	PROVIDED PARKING
228-DU @ 2.0 SPACES/DU	456	343
SURFACE PARKING (OFF-STREET)		265 (257 STD, 7 HC)
DETACHED GARAGE PARKING	N/A	78 (75 STD, 3 HC)
TOTAL (OFF-STREET)	456 (2.00 SPACES/DU)	343 (1.50 SPACES/DU)
HANDICAP SUB-TOTALS		
HANDICAP GARAGE PARKING	N/A	3 STANDARD
HANDICAPPED	9 (TOTAL)	5 STANDARD, 2 VAN

STONE MOUNTAIN - PHASE II

SITUATED IN THE SOUTHWEST 1/4 OF SECTION 03, TOWNSHIP 02 SOUTH, RANGE 68 WEST OF THE 6TH P.M. CITY OF NORTHGLENN, COUNTY OF ADAMS, STATE OF COLORADO.

PRELIMINARY & FINAL PUD AMENDMENT

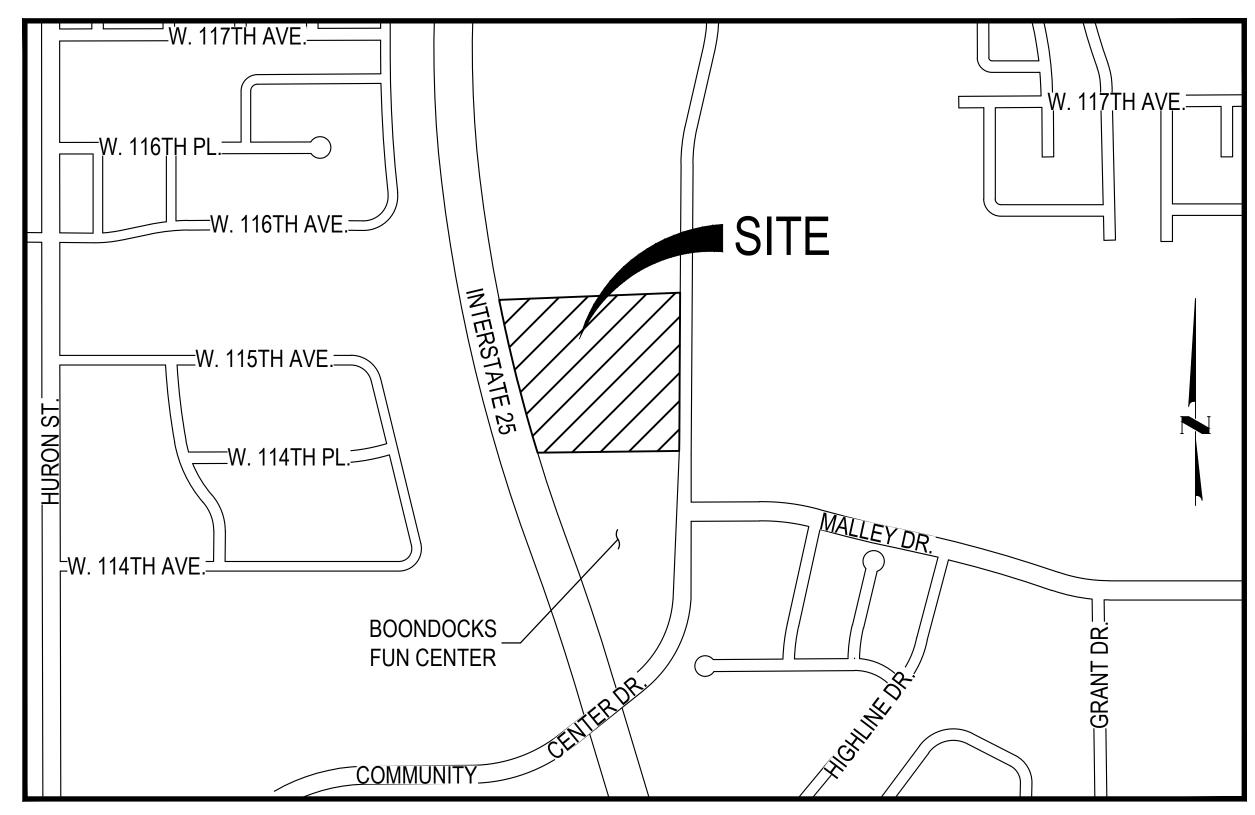

- 1. THE PUD AND INCLUDED INFORMATION SHALL ACT AS THE DESIGN GUIDELINES FOR
- THE DEVELOPMENT.
- MODIFICATION OF UP TO 10% OF ANY OF THE PERFORMANCE STANDARDS OUTLINED IN THE PUD MAY OCCUR ADMINISTRATIVELY PROVIDED THAT THE PROPOSED MODIFICATIONS MEET THE OVERALL DEVELOPMENT PATTERN, DESIGN INTENT, AND ARE SUPPORTED BY UPDATED, STAMPED, AND SEALED ENGINEERING STUDIES REFLECTING THE IMPACTS.

SHEET INDEX

- C.01 COVER SHEET
- C.02 SITE PLAN
- C.03 OVERALL GRADING PLAN C.04 OVERALL UTILITY PLAN
- A.01 EXTERIOR ELEVATIONS
- A.02 EXTERIOR ELEVATIONS A.03 EXTERIOR ELEVATIONS
- A.04 EXTERIOR ELEVATIONS
- A.05 EXTERIOR ELEVATIONS
- A.06 EXTERIOR ELEVATIONS
- A.07 EXTERIOR ELEVATIONS L.01 LANDSCAPE PLAN
- L.02 PLANT SCHEDULE AND NOTES
- L.03 LANDSCAPE DETAILS P.01 LIGHTING PLAN



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CIVIL ENGINEER:



ARCHITECTS 720 NW Davis 503,221,1121 Suite 300 503 221.2077 D Portland OR 97209 www.lrsarchitects.com

ARCHITECT:

APPROVALS:

APPROVED BY THE DIRECTOR OF PLANNING AND DEVELOPMENT

IRECTOR OF PLANNING AND DEVELOPMENT	
PPROVED BY THE DIRECTOR OF PUBLIC WORKS & UTILITIES	
IRECTOR OF PUBLIC WORKS AND UTILITIES	_
HIS PLANNED UNIT DEVELOPMENT PLAN (P.U.D.) FOR STONE MOUNTAIN — PHASE II HAS BE HE CITY OF NORTHGLENN, COLORADO ON THE DAY OF	
CHAIRMAN CLANNING COMMISSION	_

MAYOR, CITY OF NORTHGLENN

OWNER'S CERTIFICATE:

FINAL PLANNED UNIT DEVELOPMENT PLAN.

ATTESTED BY THE CITY CLERK

CITY CLERK

ADDRESS

EXECUTED THIS DAY OF,	
OWNER	TITLE
STATE OFS.S.	
COUNTY OF	
THE FOREGOING INSTRUMENT WAS ACKNOWLEDGED BEFORE ME THIS DAY	′ OF
BY	_ OF PROPOSED DEVELOPMENT.
WITNESS MY HAND AND SEAL	
MY COMMISSION EXPIRES	
NOTARY PUBLIC	

ADAMS COUNTY CLERK AND RECORDERS CERTIFICATE:

STATE OF				
COUNTY OF	5.5. 			
	THIS PLAT WAS FILED FOR RECORD IN			
AT	0'CLOCK IN BOOK	PAGE	P.U.D	RECEPTION NUME

ADAMS COUNTY CLERK AND RECORDER

SHEET TITLE: **COVER SHEET**

SHEET NUMBER: SHEET 1 OF 15



PRELIMINARY ON NORTHGLENN, COL STON

Owner:

HOLLAND PARTNERS 600 SOUTH CHERRY STREET SUITE 700 DENVER, CO 80246 303.399.0840 303.399.1397

DATE:

<u>LEGEND</u> 3-25-2013 5-31-2013 6-28-2013 ELECTRIC TRANSFORMER DETACHED GARAGE PARKING SPACE COUNT

OFF-STREET PARKING SPACE COUNT STREET LIGHT --- EXISTING FENCE

SCALE: 1"= 40'

GARAGE NUMBER DESIGNATED HANDICAP PARKING SPACE

ACCESSIBLE ROUTE

PROPOSED HANDRAIL

SHEET TITLE: SITE PLAN

> SHEET NUMBER: C.02 SHEET 2 OF 15

NOTES:

1. ALL RAMPS SHALL BE INSTALLED IN CONFORMANCE WITH ALL APPLICABLE LOCAL, STATE, AND/OR FEDERAL REGULATIONS AND STANDARDS, INCLUDING BUT NOT LIMITED TO, THE AMERICANS WITH DISABILITIES ACT (ADA), THE FAIR HOUSING ACT (FHA) AND THE AMERICAN NATIONAL STANDARDS INSTITUTE (ANSI).

2. ALL CURB RETURN RADII ARE 25' UNLESS OTHERWISE NOTED.



STONE MOUNTAIN - PHASE II

Owner:

HOLLAND PARTNERS
600 SOUTH CHERRY STREET
SUITE 700
DENVER, CO 80246

303.399.0840

303.399.1397

DATE:

3-25-2013 5-31-2013 6-28-2013

<u>LEGEND</u>

PROPOSED RETAINING WALL

RETAINING WALL HEIGHT

PROPOSED DOWNSPOUT

SCALE: 1"= 40'

PROPOSED STORM SEWER

---- PROPOSED LANDSCAPE DRAIN

= 5420 EXISTING CONTOURS

—5420 PROPOSED CONTOURS

6-28-2013

SHEET TITLE:

OVERALL
GRADING PLAN

SHEET NUMBER

SHEET NUMBER:

C.03

SHEET 3 OF 15

OTES:

- 1. ALL RAMPS SHALL BE INSTALLED IN CONFORMANCE WITH ALL APPLICABLE LOCAL, STATE, AND/OR FEDERAL REGULATIONS AND STANDARDS, INCLUDING BUT NOT LIMITED TO, THE AMERICANS WITH DISABILITIES ACT (ADA), THE FAIR HOUSING ACT (FHA) AND THE AMERICAN NATIONAL STANDARDS INSTITUTE (ANSI).
- 2. SIDEWALK CROSS-SLOPES SHALL NOT EXCEED 2%. LONGITUDINAL WALK SLOPES SHALL NOT EXCEED 5% EXCEPT WHERE RAMPS ARE SPECIFIED.



STONE MOUNTAIN - PHASE II PRELIMINARY & FINAL PUD AMENDMENT NORTHGLENN, COLORADO HOLLAND PARTNERS

Owner:

HOLLAND PARTNERS
600 SOUTH CHERRY STREET
SUITE 700
DENVER, CO 80246
303.399.0840
303.399.1397

DATE: 3-25-2013 5-31-2013 6-28-2013

5-31-2013 6-28-2013

SHEET TITLE:
OVERALL UTILITY
PLAN

SHEET NUMBER:

SHEET 4 OF 15

SCALE: 1"= 40'



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COLOR ELEVATIONS

SIDING, ASSOCIATED CORNER TRIM, VENTS AND DOWNSPOUTS. COLOR TO MATCH SW 6122

SIDING, ASSOCIATED CORNER TRIM, VENTS AND DOWNSPOUTS. COLOR TO MATCH SW 6165

SIDING, ASSOCIATED CORNER TRIM, VENTS AND DOWNSPOUTS. COLOR TO MATCH SW 7044 AMAZING

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SIDING, ASSOCIATED CORNER TRIM, VENTS AND DOWNSPOUTS. COLOR TO MATCH SW 6163

SIDING, ASSOCIATED CORNER TRIM, VENTS AND DOWNSPOUTS. COLOR TO MATCH SW 6244 NAVAL

MATICHUE WHITE ANTIQUE WHITE

AVAILABLE UPON REQUEST

PAINT LEGEND

PAINT ENTIRE BUILDING USING ONE COLOR SCHEME

COLOR SCHEME BUILDING LOCATIONS SELECTED BY OWNER

CAMELBACK

GRASSLAND

CONNECTED GRAY

OWNER: HOLLAND PARTNERS 600 SOUTH CHERRY STREET SUITE 700 **DENVER, CO 80246**

303.399.0840

303.399.1397

BLDG TYPE A1

DATE:

06/28/13

SHEET TITLE: **EXTERIOR ELEVATION**

SHEET NUMBER: A.01 SHEET 5 OF 15

BUILDING TYPE A1 - TYPICAL END ELEVATION

SCALE: 1/8"=1'-0"



2. BUILDING TYPE A1 - TYPICAL SIDE ELEVATION

SCALE: 1/8"=1'-0"

CHECKED BY: DRAWN BY:



SEE BUILDING TYPE A1 FOR TYPICAL NOTES

SEE BUILDING TYPE A1 FOR TYPICAL NOTES

1. BUILDING TYPE A2 - TYPICAL END ELEVATION

COLOR SCHEME 1 — COLOR SCHEME 2

COLOR SCHEME

CHECKED BY: JN DRAWN BY: CM

BUILDING TYPE A2 - TYPICAL SIDE ELEVATION

SCALE: 1/8"=1'-0"

SCALE: 1/8"=1'-0"

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STONE MOUNTAIN - PHASE
PRELIMINARY AND FINAL PUD AMENDMENT
NORTHGLENN, COLORADO

OWNER:

HOLLAND PARTNERS
600 SOUTH CHERRY STREET
SUITE 700
DENVER, CO 80246
303.399.0840
303.399.1397

BLDG
TYPE A2
L

DATE: /28/13

06/28/13

SHEET TITLE: EXTERIOR ELEVATION

SHEET NUMBER:
A.02
SHEET 6 OF 15



PAINT LEGEND

COLOR ELEVATIONS AVAILABLE UPON REQUEST

PAINT ENTIRE BUILDING USING ONE COLOR SCHEME COLOR SCHEME BUILDING LOCATIONS SELECTED BY OWNER

SIDING, ASSOCIATED CORNER TRIM, VENTS AND DOWNSPOUTS. COLOR TO MATCH SW 6122 CAMELBACK

SIDING, ASSOCIATED CORNER TRIM, VENTS AND DOWNSPOUTS. COLOR TO MATCH SW 6165 CONNECTED GRAY

SIDING, ASSOCIATED CORNER TRIM, VENTS AND DOWNSPOUTS. COLOR TO MATCH SW 7044 AMAZING GRAY

EP-4

WOOD FASCIA, DOOR AND WINDOW TRIM. COLOR TO MATCH SW 6119 ANTIQUE WHITE

SIDING, ASSOCIATED CORNER TRIM, VENTS AND DOWNSPOUTS. COLOR TO MATCH SW 6163 GRASSLAND

SIDING, ASSOCIATED CORNER TRIM, VENTS AND DOWNSPOUTS. COLOR TO MATCH SW 6244 NAVAL

SEE BUILDING TYPE A1 FOR TYPICAL NOTES

1. BUILDING TYPE A3 - TYPICAL END ELEVATION

SCALE: 1/8"=1'-0"

COLOR SCHEME 2

ALTER COLOR SCHEME 2

ALTER

SEE BUILDING TYPE A1 FOR TYPICAL NOTES

BUILDING TYPE A3 - TYPICAL SIDE ELEVATION

SCALE: 1/8"=1'-0"

CHECKED BY: DRAWN BY: NORRIS DESIGN
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PRELIMINARY AND FINAL PUD AMENDMENT
NORTHGLENN, COLORADO


OWNER:
HOLLAND PARTNERS
600 SOUTH CHERRY STREET
SUITE 700
DENVER, CO 80246
303.399.0840
303.399.1397

BLDG TYPE A3

DATE: 06/28/13

SHEET TITLE:
EXTERIOR
ELEVATION
SHEET NUMBER:
A.03

SHEET 7 OF 15

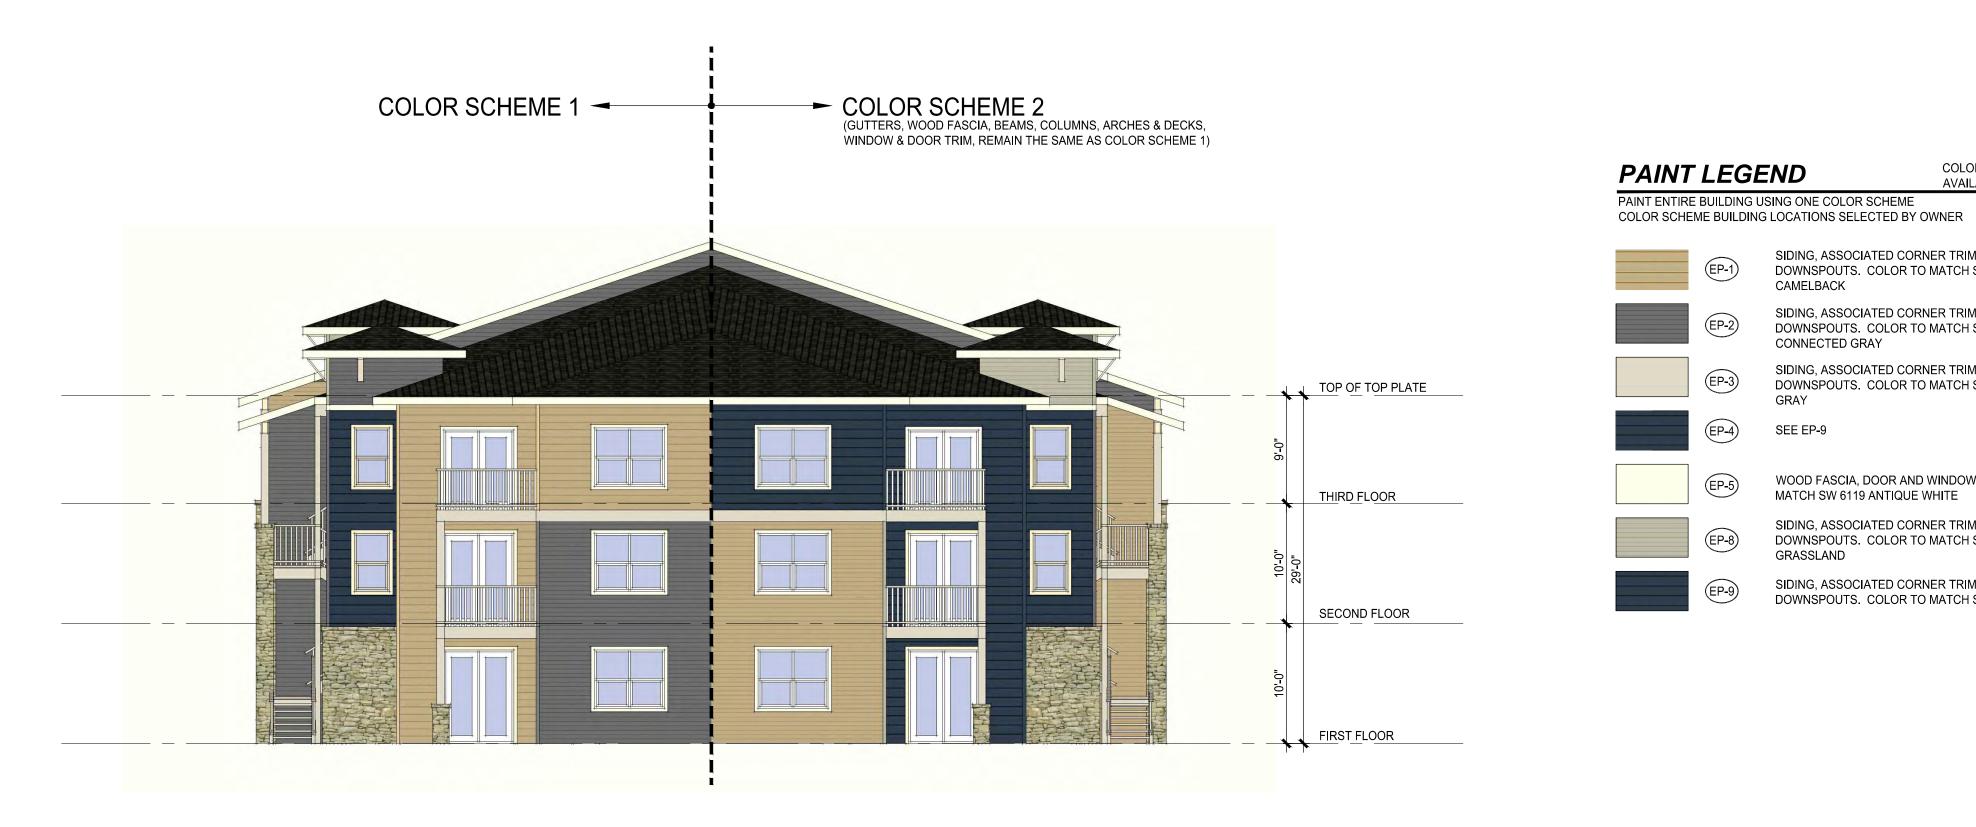

SEE BUILDING TYPE A1 FOR TYPICAL NOTES

1. BUILDING TYPE A4 - TYPICAL END ELEVATION



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COLOR ELEVATIONS AVAILABLE UPON REQUEST

SIDING, ASSOCIATED CORNER TRIM, VENTS AND DOWNSPOUTS. COLOR TO MATCH SW 6122

SIDING, ASSOCIATED CORNER TRIM, VENTS AND DOWNSPOUTS. COLOR TO MATCH SW 6165

SIDING, ASSOCIATED CORNER TRIM, VENTS AND DOWNSPOUTS. COLOR TO MATCH SW 7044 AMAZING

WOOD FASCIA, DOOR AND WINDOW TRIM. COLOR TO

SIDING, ASSOCIATED CORNER TRIM, VENTS AND DOWNSPOUTS. COLOR TO MATCH SW 6163

SIDING, ASSOCIATED CORNER TRIM, VENTS AND DOWNSPOUTS. COLOR TO MATCH SW 6244 NAVAL

MATCH SW 6119 ANTIQUE WHITE

CAMELBACK

GRASSLAND

EP-4

EP-8

CONNECTED GRAY

OWNER: HOLLAND PARTNERS 600 SOUTH CHERRY STREET SUITE 700 DENVER, CO 80246 303.399.0840 303.399.1397

BLDG TYPE A4

DATE: 06/28/13

SHEET TITLE: **EXTERIOR ELEVATION** SHEET NUMBER: **A.04**

SHEET 8 OF 15



1101 Bannock Street Denver, Colorado 80204 P 303.892.1166 F 303.892.1186

TONE MOUNTAIN - PHASE II

OWNER:

HOLLAND PARTNERS
600 SOUTH CHERRY STREET
SUITE 700


DENVER, CO 80246 303.399.0840 303.399.1397

DATE: 06/28/13

SHEET TITLE:
EXTERIOR

SHEET NUMBER:
A.05
SHEET 9 OF 16

ELEVATION

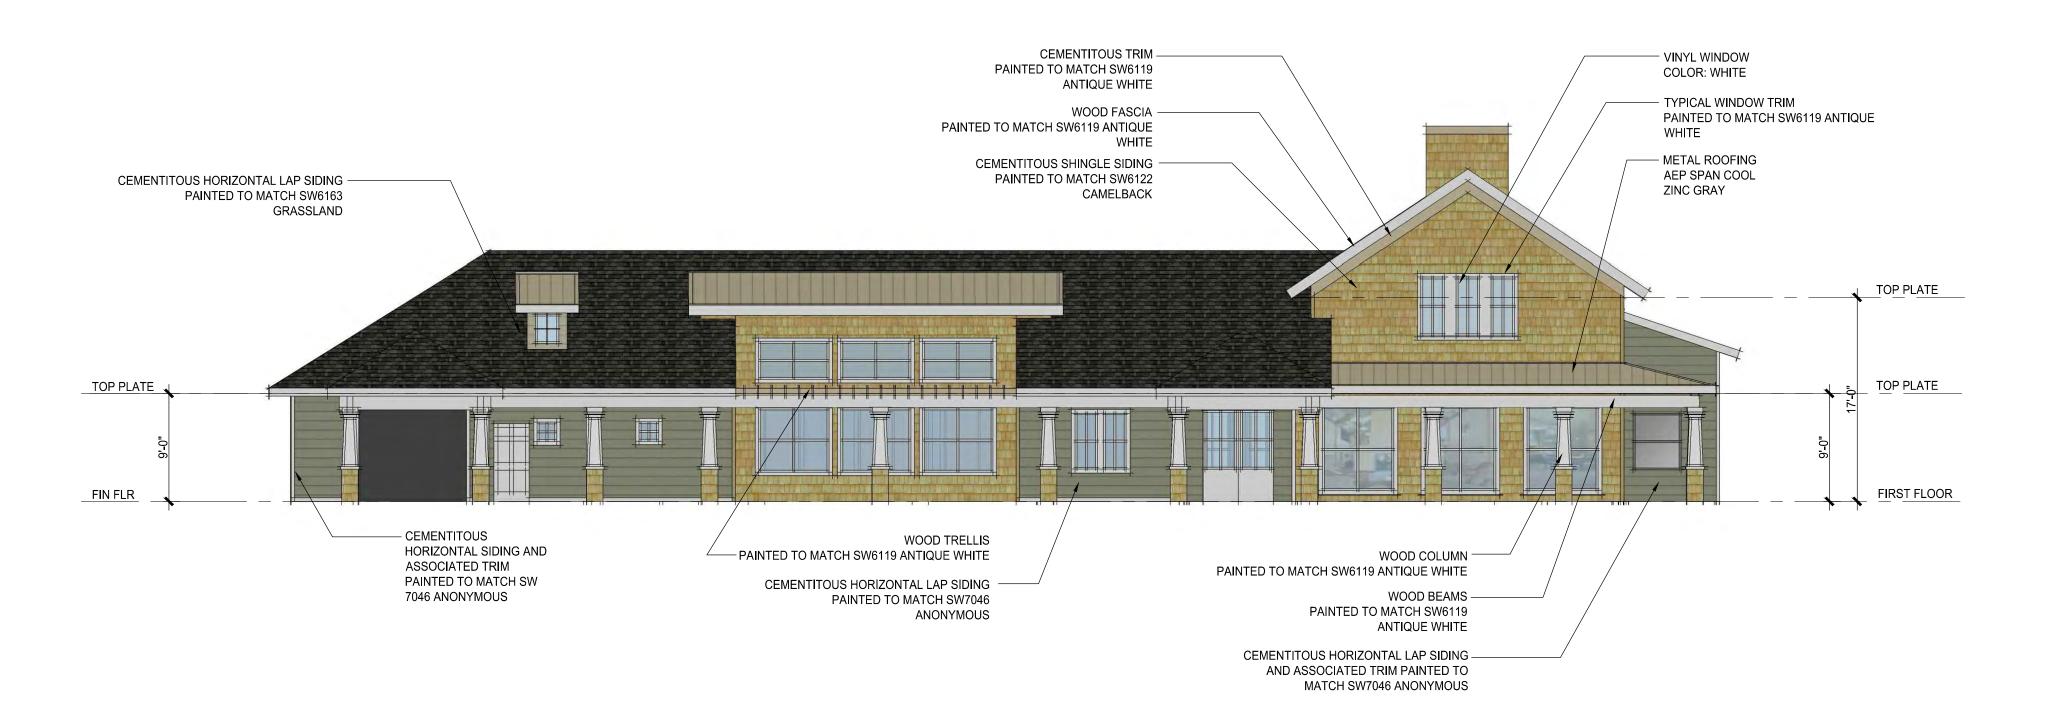

1. COMMUNITY BUILDING ELEVATION 1

SCALE: 1/8"=1'-0"



2. COMMUNITY BUILDING ELEVATION 2

SCALE: 1/8"=1'-0"



1101 Bannock Street Denver, Colorado 80204 P 303.892.1166 F 303.892.1186

OWNER: HOLLAND PARTNERS 600 SOUTH CHERRY STREET SUITE 700 DENVER, CO 80246 303.399.0840 303.399.1397

DATE:

06/28/13

SHEET TITLE: **EXTERIOR ELEVATION** SHEET NUMBER: A.06

SHEET 10 OF 15




1. COMMUNITY BUILDING BACK ELEVATION 1




2. COMMUNITY BUILDING BACK ELEVATION 2 SCALE: 1/8"=1'-0"

1. REAR ELEVATION

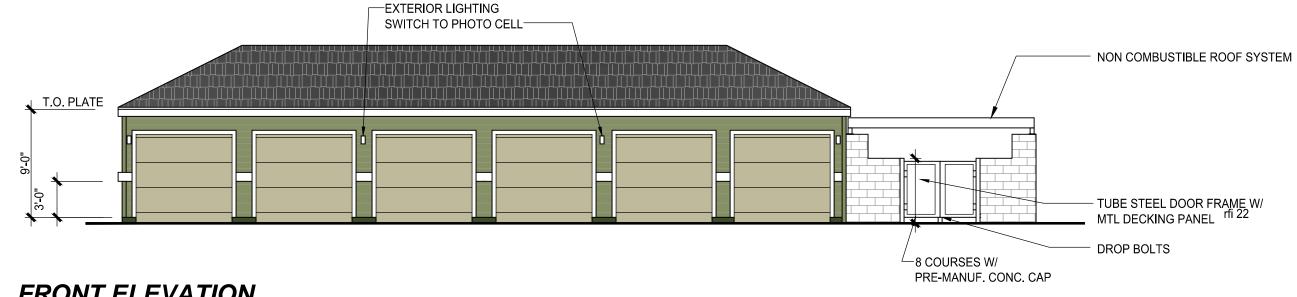


3. FRONT ELEVATION


SCALE: 1/8"=1'-0"

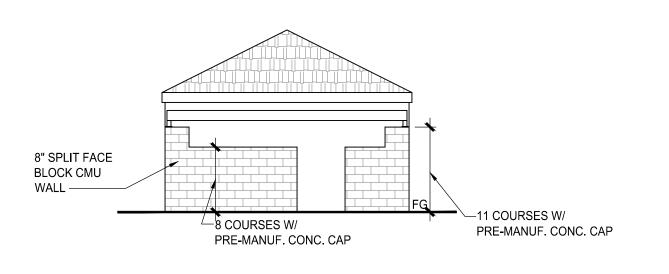


5. SIDE ELEVATION

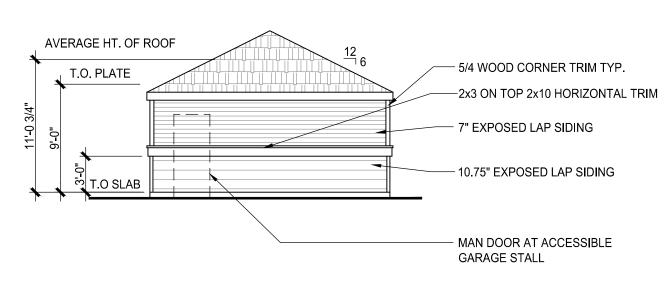


6. SIDE ELEVATION

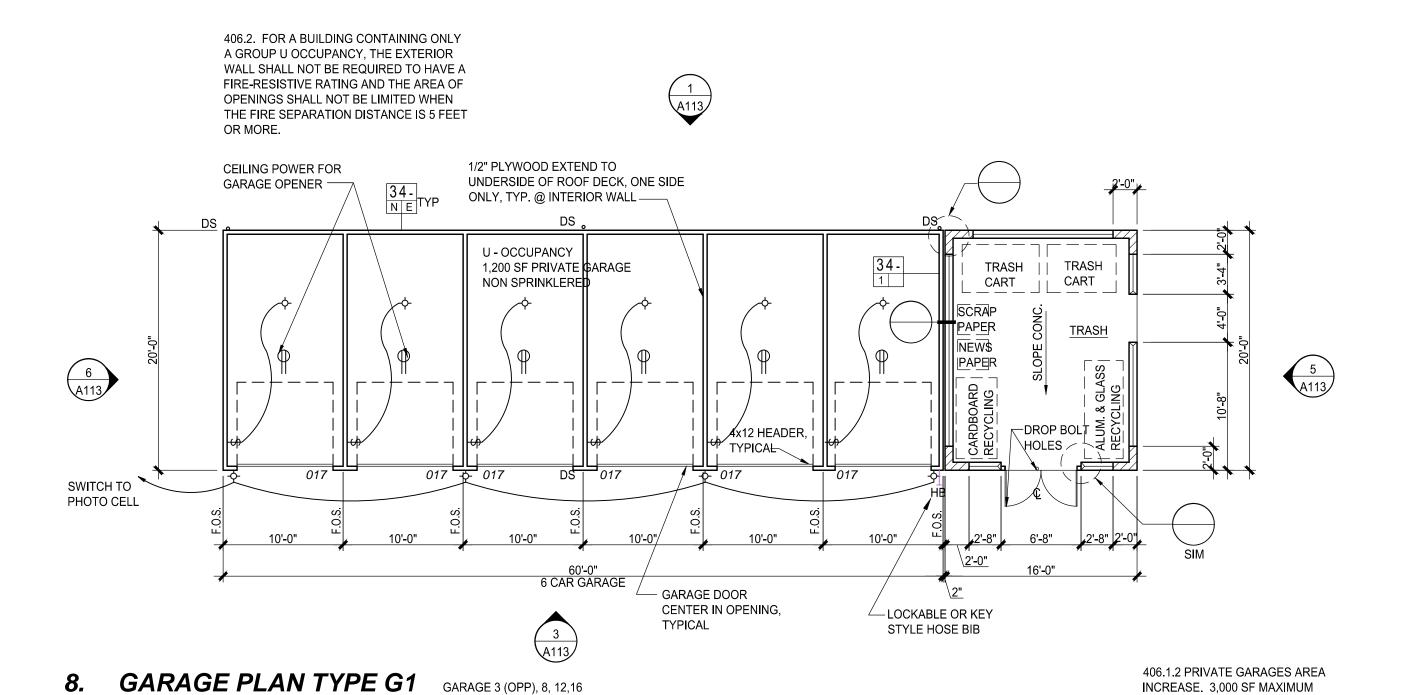

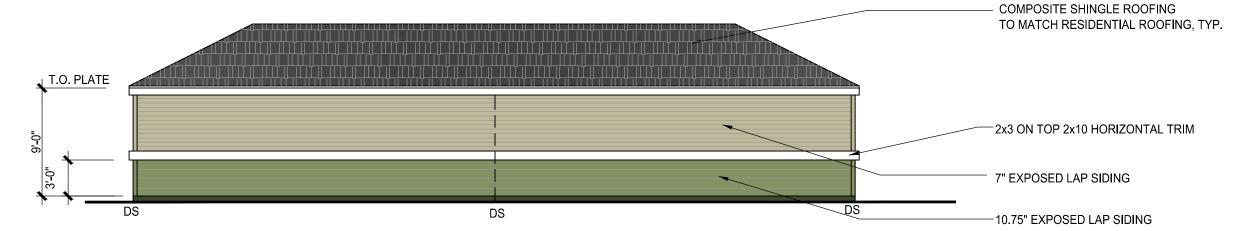


2. REAR ELEVATION SCALE: 1/8"=1'-0"

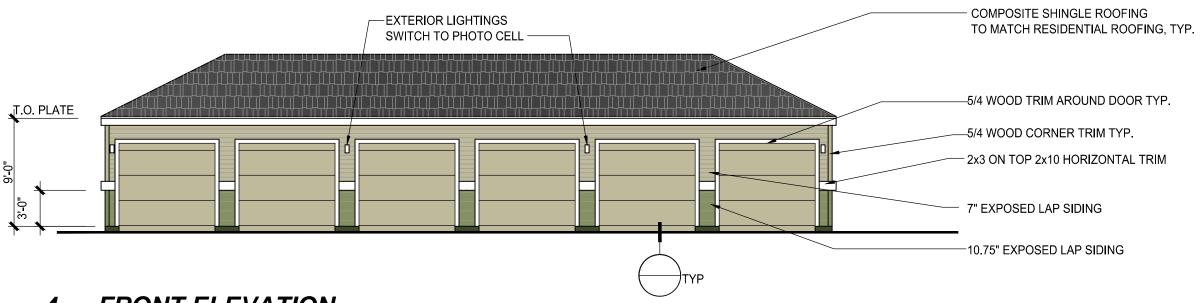


4. FRONT ELEVATION

SCALE: 1/8"=1'-0"

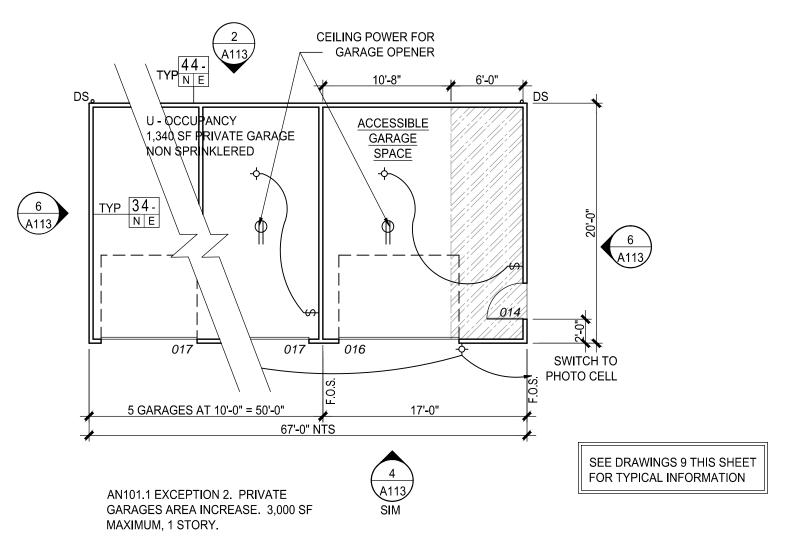

7. GARAGE ACCESSIBLE STALL PLAN TYPE G2

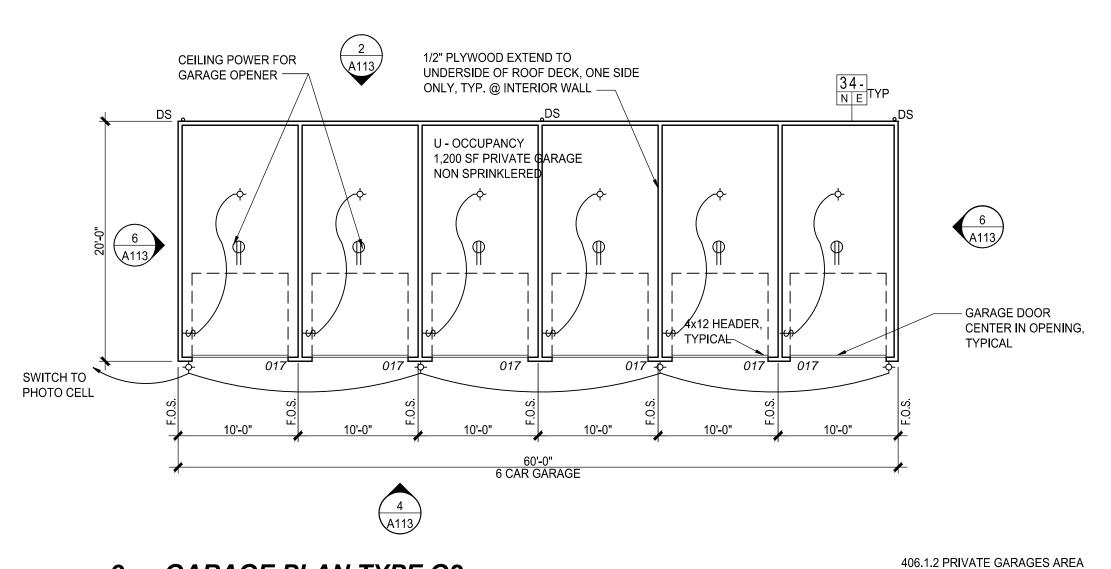

9. GARAGE PLAN TYPE G3 GARAGE 2, 4, 5, 6, 7, 9, 10, 11, 14, 15, 17, 18

INCREASE. 3,000 SF MAXIMUM

NORRIS DESIGN www.norris-design.com

1101 Bannock Street Denver, Colorado 80204 P 303.892.1166 F 303.892.1186

OWNER: HOLLAND PARTNERS 600 SOUTH CHERRY STREET SUITE 700 DENVER, CO 80246 303.399.0840

303.399.1397

DATE: 06/28/13

SHEET TITLE: **EXTERIOR ELEVATION** SHEET NUMBER: A.07 SHEET 11 OF 15



1101 Bannock Street Denver, Colorado 80204 P 303.892.1166 F 303.892.1186

F 303.892

OWNER:

HOLLAND PARTNERS


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DATE:


03/29/2013

05/31/2013 06/28/2013

LEGEND

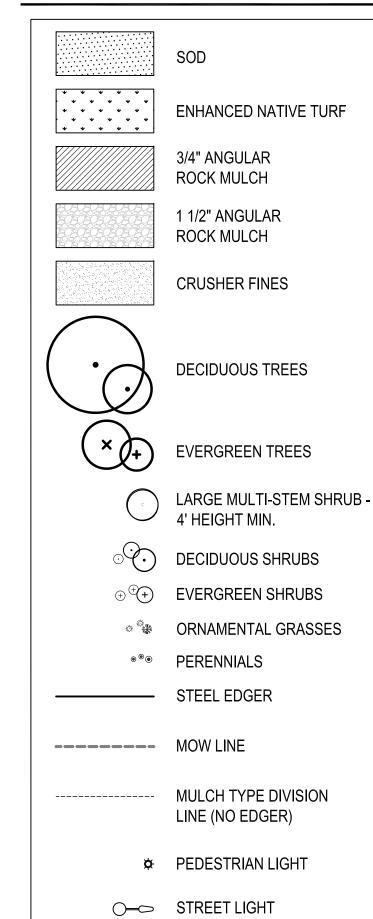

Know what's below.
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SHEET TITLE:
LANDSCAPE
PLAN
SHEET NUMBER:
L.01

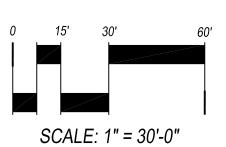SHEET 12 OF 15

LANDSCAPE NOTES:

- 1. ALL TREES ARE TO BE SECURELY GUYED FOR ONE YEAR PER DETAILS.
- 2. ALL SHRUB BEDS SHALL BE MULCHED WITH MIN. 3" DEPTH ROCK MULCH OVER GEOTEXTILE FABRIC.
- 3. ALL PLANTING BEDS ARE TO BE CONTAINED BY 4" 1/8" THICK PERFORATED GALVANIZED EDGER. EDGER IS NOT REQUIRED WHEN BED IS ADJACENT TO CURBS, WALLS, WALKS, OR CONCRETE PANS. EDGER SHALL BE KINK FREE AND SMOOTH FLOWING IN CURVED
- 4. ALL TREE PITS IN SODDED AREAS ARE TO RECEIVE A 2-1/2" DIA. 2-1/2 DEPTH SHREDDED CEDAR MULCH RING. NO EDGER OR WEED CONTROL FABRIC IS REQUIRED.
- 5. ALL IRRIGATION DEVELOPMENT IS TO BE UNDERGROUND, AUTOMATIC, AND PROVIDE 100% COVERAGE TO ALL AREAS.

PLANT SCHEDULE:

WATER USE	SYM.	COMMON NAME	BOTANICAL NAME	SIZE & COND.	QTY.
XX DECIDUOUS CAN			ULMUS WILSONIANA 'PROSPECTOR'	2.5" CAL. B&B	
			TILIA CORDATA 'GREENSPIRE'	2.5" CAL. B&B	
xx			CATALPA SPECIOSA	2.5" CAL. B&B	
			CELTIS OCCIDENTALIS	2.5" CAL. B&B	
			GYMNOCLADUS DIOICUS 'ESPRESSO' QUERCUS RUBRA	2.5" CAL. B&B 2.5" CAL. B&B	
			FRAXINUS AMERICANA 'AUTUMN PURPLE'	2.5" CAL. B&B	
		SHADEMASTER HONEYLOCUST	GLEDITSIA TRIACANTHOS 'SHADEMASTER'	2.5" CAL. B&B	
			CLADRASTIS KENTUKEA	2.5" CAL. B&B 2.5" CAL. B&B	
		LANCELEAF COTTONWOOD 6' HEIGHT (UNLESS NOTED LARGER ON PLA	POPULUS X ACUMINATA N)	2.5 CAL. B&B	
			PINUS NIGRA	8' HT. B&B (LARGE SYMBOL)	
			PINUS PONDEROSA	8' HT. B&B (LARGE SYMBOL)	
			PICEA PUNGENS	6' HT. B&B (SMALL SYMBOL)	
			PINUS FLEXILIS PINUS EDULIS	6' HT. B&B (SMALL SYMBOL) 6' HT. B&B (SMALL SYMBOL)	
		SKYROCKET JUNIPER	JUNIPERUS VIRGINIANA 'SKYROCKET'	6' HT. B&B (VERY SMALL SYMBOL)	
DECIDUOUS ORN					
XX XX			PRUNUS CALLERYANA 'CHANTICLEER' QUERCUS 'CRIMSCHMIDT'	2.0" CAL. B&B 2.0" CAL. B&B	
			KOELREUTERIA PANICULATA	2.0" CAL. B&B	
x	RAD	RADIANT CRAB	MALUS X 'RADIANT'	2.0" CAL. B&B	
			MALUS X 'SPRING SNOW'	2.0" CAL. B&B	
			CRATAEGUS CRUSS-GALLI INERMIS	2.0" CAL. B&B	
			AMELANCHIER X GRANDIFLORA ACER TATARICUM 'PATTERN PERFECT'	6'-8' HT. MULTISTEM B&B 6'-8' HT. MULTISTEM B&B	
LARGE MULTI-ST					
			HIBISCUS SYRIACUS 'LAVENDER CHIFFON'	4' HT., B&B, MULTISTEM	
			PRUNUS CISTENA VIBURNUM DENTATUM 'RALPH SENIOR'	4' HT., B&B, MULTISTEM 4' HT., B&B, MULTISTEM	
X EVERGREEN SHR		AUTUMN JAZZ VIBURNUM	VIBURNUM DENTATUM 'RALPH SENIOR'	H ΠΙ., DαD, WULTISTEM	
		OREGON GRAPE HOLLY 'KING'S RANSOM'	M. AQUIFOLIUM 'KINGS RANSOM'	#5 CONT.	
			EYONYMUS KIAUTSCHOVICA 'MANHATTAN'	#5 CONT.	
		ARMSTRONG JUNIPER	JUNIPERUS CHINENSIS "ARMSTRONG"	#5 CONT.	
		GREENMOUND JUNIPER GLOBE SPRUCE	JUNIPERUS PROCUMBENS 'GREEN MOUND' PICEA PUNGENS 'GLOBOSA'	#5 CONT. #5 CONT.	
	1	PANCHITO MANZANITA	ARCTOSTAPHYLOS 'PANCHITO'	#5 CONT.	
	COL	COLOGREEN JUNIPER	JUNIPERUS SCOPULORUM 'COLOGREEN'	#5 CONT.	
			PINUS MUGO 'MOPS'	#5 CONT.	
			D. X BURKWOODI 'CAROL MACKIE' JUNIPERUS VIRGINIANA 'SKYROCKET'	#5 CONT. #5 CONT.	
			Y. FILAMENTOSA	#5 CONT.	
			PICEA PUNGENS 'R.H. MONTGOMERY'	#5 CONT.	
DECIDUOUS SHRI				Luc cont	
			BERBERIS THUNBERGII 'ATROPURPUREA NANA' CARAGANA PYGMAEA	#5 CONT. #5 CONT.	
			RHAMNUS FRANGULA 'RON WILLIAMS'	#5 CONT.	
x	BDW	PURPLE HAZE BUTTERFLY BUSH	BUDDLEIA X 'PURPLE HAZE'	#5 CONT.	
XX			LIGUSTRUM VULGARE 'LODENSE'	#5 CONT.	
			SYMPHORICARPOS X CHENAULT 'HANCOCK' ROSA 'RADSUNNY' (YELLOW)	#5 CONT. #5 CONT.	
			ROSA 'RADRAZZ' (RED)	#5 CONT.	
xx	DRS	DWARF RUSSIAN SAGE	PEROVSKIA ARTIPLICIFOLIA 'LITTLE SPIRE'	#5 CONT.	
DECIDUOUS SHRI				Lyn cour	
			PHYSOCARPUS OPULIFOLIUS 'NANUS' CARYOPTERIS X CLANDONENSIS	#5 CONT. #5 CONT.	
			PRUNUS BESSEYI 'PAWNEE BUTTES'	#5 CONT.	
	YFC	YELLOW FLOWERING CURRANT	RIBES AUREUM	#5 CONT.	
		KOREAN SPICE VIBURNUM	VIBURNUM CARLESII	#5 CONT.	
			SYRINGA PATULA 'MISS KIM' CHRYSOTHAMNUS NAUSEOSUS ALBICAULIS	#5 CONT. #5 CONT.	
			RHUS TRILOBATA	#5 CONT.	
X			RIBES ALPINUM	#5 CONT.	
DECIDUOUS SHRI			SYRINGA VULGARIS	#5 CONT.	
		RED TWIG DOGWOOD	CORNUS SERICIEA 'BAILEYI'	#5 CONT.	
			CORNUS SERICEA 'FLAVIRAMEA'	#5 CONT.	
		NEW MEXICO PRIVET ALL GRASSES 1 GAL. CONT. UNLESS SPECIFI	FORESTIERA NEOMEXICANA ED OTHERWISE ON THE PLAN)	#5 CONT.	
	<u> </u>		HELICTOTRICHON SEMPERVIRENS	#1 CONT.	
x	FRG	FEATHER REED GRASS	CALAMAGROSTIS ARUNDINACEA 'KARL FOERSTER'	#1 CONT.	
			MISCANTHUS SINENSIS 'GRACILLIMUS'	#1 CONT.	
X XXX			PENNISETUM SETACEUM 'RUBRUM' SCHIZACHYRIUM SCOPARIUM	#1 CONT. #1 CONT.	
			PANICUM VIRGATUM 'SHENANDOAH'	#1 CONT.	
X	HPG	HARDY PLUME GRASS	ERIANTHUS RAVENNAE	#5 CONT.	
	PER	ALITHMA IOV OFFILM	OFFILM MALITIM ALLION	LIVA CONT	
		AUTUMN JOY SEDUM RED VALERIAN/JUPITER'S BEARD	SEDUM 'AUTUMN JOY' CENTRANTHUS RUBER	#1 CONT. #1 CONT.	
			AGASTACHE RUPESTRIS	#1 CONT.	
xx	WBF		G. LINDHEIMERI	#1 CONT.	
			LAVANDULA ANGUSTIFOLIA 'MUNSTEAD'	#1 CONT.	
			PERSICARIA AFFINIS RUDBECKIA FULGIDA 'GOLDSTRUM'	#1 CONT. #1 CONT.	
			HEMEROCALIS HYBRID	#1 CONT.	
			HEMEROCALIS 'STELLA D'ORO'	#1 CONT.	
			G. LINEARIS 'COLORADO GOLD'	#1 CONT.	
			DELOSPERMA FLORIBUNDA	#1 CONT.	
			LIATRIS SPICATA 'KOBOLD' SALVIA SYLVESTRIS X 'MAY NIGHT'	#1 CONT. #1 CONT.	
			ECHINACEA PURPUREA	#1 CONT.	
			ACHILLEA MILLEFOLIUM 'PAPRIKA'	#1 CONT.	
			HOSTA FORTUNEI 'PATRIOT' HEUCHERA MICRANTHA 'PURPLE PALACE'	#1 CONT. #1 CONT.	
			ARTEMESIA SCHMIDTIANA	#1 CONT.	



1101 Bannock Street Denver, Colorado 80204 P 303.892.1166 F 303.892.1186

OWNER: HOLLAND PARTNERS 600 SOUTH CHERRY STREET SUITE 700 DENVER, CO 80246 303.399.0840 303.399.1397

03/29/2013 05/31/2013 06/28/2013	03/29/2013 05/31/2013
	05/31/2013
06/28/2013	00/01/2010
	06/28/2013

SHEET TITLE: PLANT SCHEDULE & NOTES SHEET NUMBER:

L.02

SHEET 13 OF 15

Know what's below.

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— O.C. SPACING


1 SPECIFIED MULCH

AMENDED SOIL IN PLANTING BED (2) PER SPECIFICATIONS. TILL SOIL TO A DEPTH OF EIGHT INCHES.

(3) FINISH GRADE (TOP OF MULCH)

1. BROKEN OR CRUMBLING ROOT-BALLS WILL BE REJECTED

- 2. CARE SHOULD BE TAKEN NOT TO DAMAGE THE SHRUB OR ROOT-BALL WHEN REMOVING IT FROM ITS CONTAINER
- 3. ALL JUNIPERS SHOULD BE PLANTED SO THE TOP OF THE ROOT-BALL OCCURS ABOVE THE FINISH GRADE OF THE MULCH LAYER
- 4. DIG PLANT PIT TWICE AS WIDE AND HIGH AS THE CONTAINER

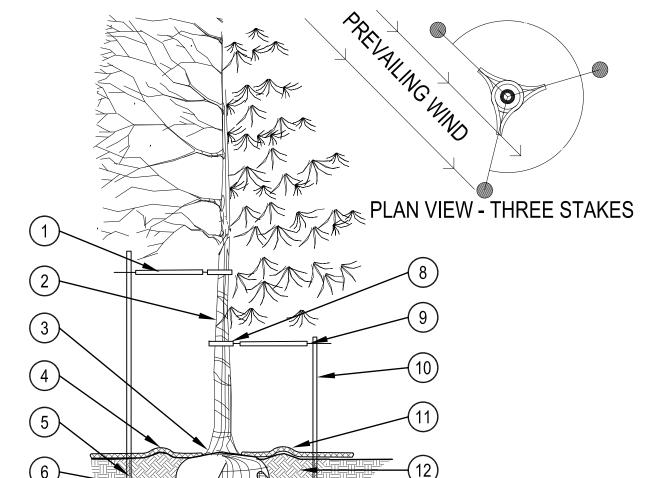

ROOT BALL DIAMETER

TREE PLANTING DETAIL

PRUNING NOTES:

ALL PRUNING SHALL COMPLY WITH ANSI A300 STANDARDS.

2. DO NOT HEAVILY PRUNE THE TREE AT PLANTING. PRUNE ONLY CROSSOVER LIMBS, CO-DOMINANT LEADERS AND BROKEN BRANCHES. SOME INTERIOR TWIGS AND LATERAL BRANCHES MAY BE PRUNED. HOWEVER, DO NOT REMOVE THE TERMINAL BUDS OF BRANCHES THAT EXTEND TO THE EDGE OF THE CROWN.

STAKING NOTES:

FENCING SHALL BE BY

APPROVED EQUAL

SCALE: 3/4" = 1'-0"

PLAY MONTAGE PLUS OR

AMERISTAR FENCE - POOL PET

1. STAKE TREES PER FOLLOWING SCHEDULE, THEN REMOVE AT END OF FIRST GROWING SEASON. FOLLOWS:

- $1-\frac{1}{2}$ " CALIPER SIZE MIN. 1 STAKE ON SIDE OF PREVAILING WIND (GENERALLY N.W. SIDE) $1-\frac{1}{2}$ " - 3" CALIPER SIZE - MIN. 2 STAKES - ONE ON N.W. SIDE, ONE ON S.W. SIDE (OR PREVAILING WIND SIDE AND 180° FROM THAT SIDE)
- 1.3 3" CALIPER SIZE AND LARGER 3 STAKES PER DIAGRAM 2. WIRE OR CABLE SHALL BE MIN. 12 GAUGE, TIGHTEN WIRE OR CABLE ONLY ENOUGH TO KEEP FROM SLIPPING. ALLOW FOR SOME TRUNK MOVEMENT. NYLON STRAPS SHALL BE LONG ENOUGH TO ACCOMMODATE $1-\frac{1}{2}$ " OF GROWTH AND BUFFER ALL BRANCHES FROM WIRE.

1 PLACE MIN. 2" PVC PIPE AROUND 8 GROMMETED NYLON STRAPS EACH WIRE. EXPOSED WIRE SHALL BE MAX. 2" EACH SIDE

(2) TREE WRAP TO BE INSTALLED ONLY FROM OCTOBER 1 THROUGH APRIL 30. (DECIDUOUS 10) 6 FT. STEEL T-POST (SEE

(3) PLANT TREE SO THAT FIRST ORDER MAJOR ROOT IS 1"-2" ABOVE FINAL GRADE.

(4) 3" DEEP MULCH RING PLACED A MINIMUM OF 4 FT. IN DIAMETER. DO NOT PLACE MULCH IN CONTACT WITH TREE TRUNK (FINISHED GRADE REFERENCES TOP OF MULCH).

5 1:1 SLOPE ON SIDES OF PLANTING PLACE ROOT BALL ON HOLE. SETTLEMENT.

6 REMOVE ALL TWINE, ROPE, BURLAP AND WIRE FROM ENTIRE ROOT BALL AND TRUNK

7 PLACE SOIL AROUND ROOT BALL FIRMLY, DO NOT COMPACT OR TAMP. SETTLE SOIL WITH WATER TO FILL ALL AIR POCKETS.

(9) GALVANIZED WIRE, MIN. 12

GAUGE CABLE - TWIST WIRE ONLY TO KEEP FROM SLIPPING.

SCHEDULE). ALL SHALL BE DRIVEN OUTSIDE ROOTBALL AND IN UNDISTURBED SOIL.

(11) 4-6" HIGH WATER SAUCER IN NON-TURF AREAS.

12) BACKFILL WITH BLEND OF EXISTING SOIL AND A MAXIMUM 20% (BY VOLUME) ORGANIC MATERIAL. WATER THOROUGHLY WHEN BACKFILLING

UNDISTURBED SOIL TO PREVENT

SHRUB PLANTING


PERENNIAL PLANT LAYOUT

SCALE: 1-1/2" = 1'-0"

1 SPECIFIED MULCH

2 AMENDED PLANTING BED TILLED TO A DEPTH OF 6"

(3) CENTER OF PLANT

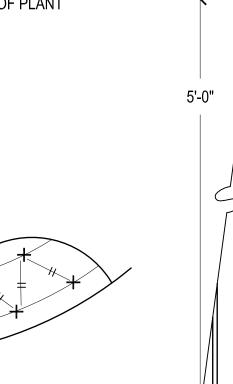

SCALE: 1" = 1'-0"

WHEN PLANTED ON A CURVE ORIENT ROWS TO FOLLOW

THE LONG AXIS OF AREAS WHERE PLANTS ARE MASSED

POOL FENCE

SCALE: 3/16" = 1'-0"

OWNER:

NORRIS DESIGN www.norris-design.com

1101 Bannock Street

P 303.892.1166

F 303.892.1186

Denver, Colorado 80204

HOLLAND PARTNERS 600 SOUTH CHERRY STREET SUITE 700 DENVER, CO 80246 303.399.0840 303.399.1397

DATE: 03/29/2013 05/31/2013

06/28/2013

SHEET TITLE: LANDSCAPE **DETAILS**

SHEET NUMBER: L.03 SHEET 14 OF 15

Know what's below.


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SHEET TITLE: LIGHTING PLAN

SHEET NUMBER: P.01 SHEET 15 OF 15

IMPACT E NGINEERING, INC.
554 Remington Place
Castle Rock, Colorado 80108
Phone: 303-873-6670 Cell: 303-877-9669
email: brian@impactengineeringinc.com



LLF

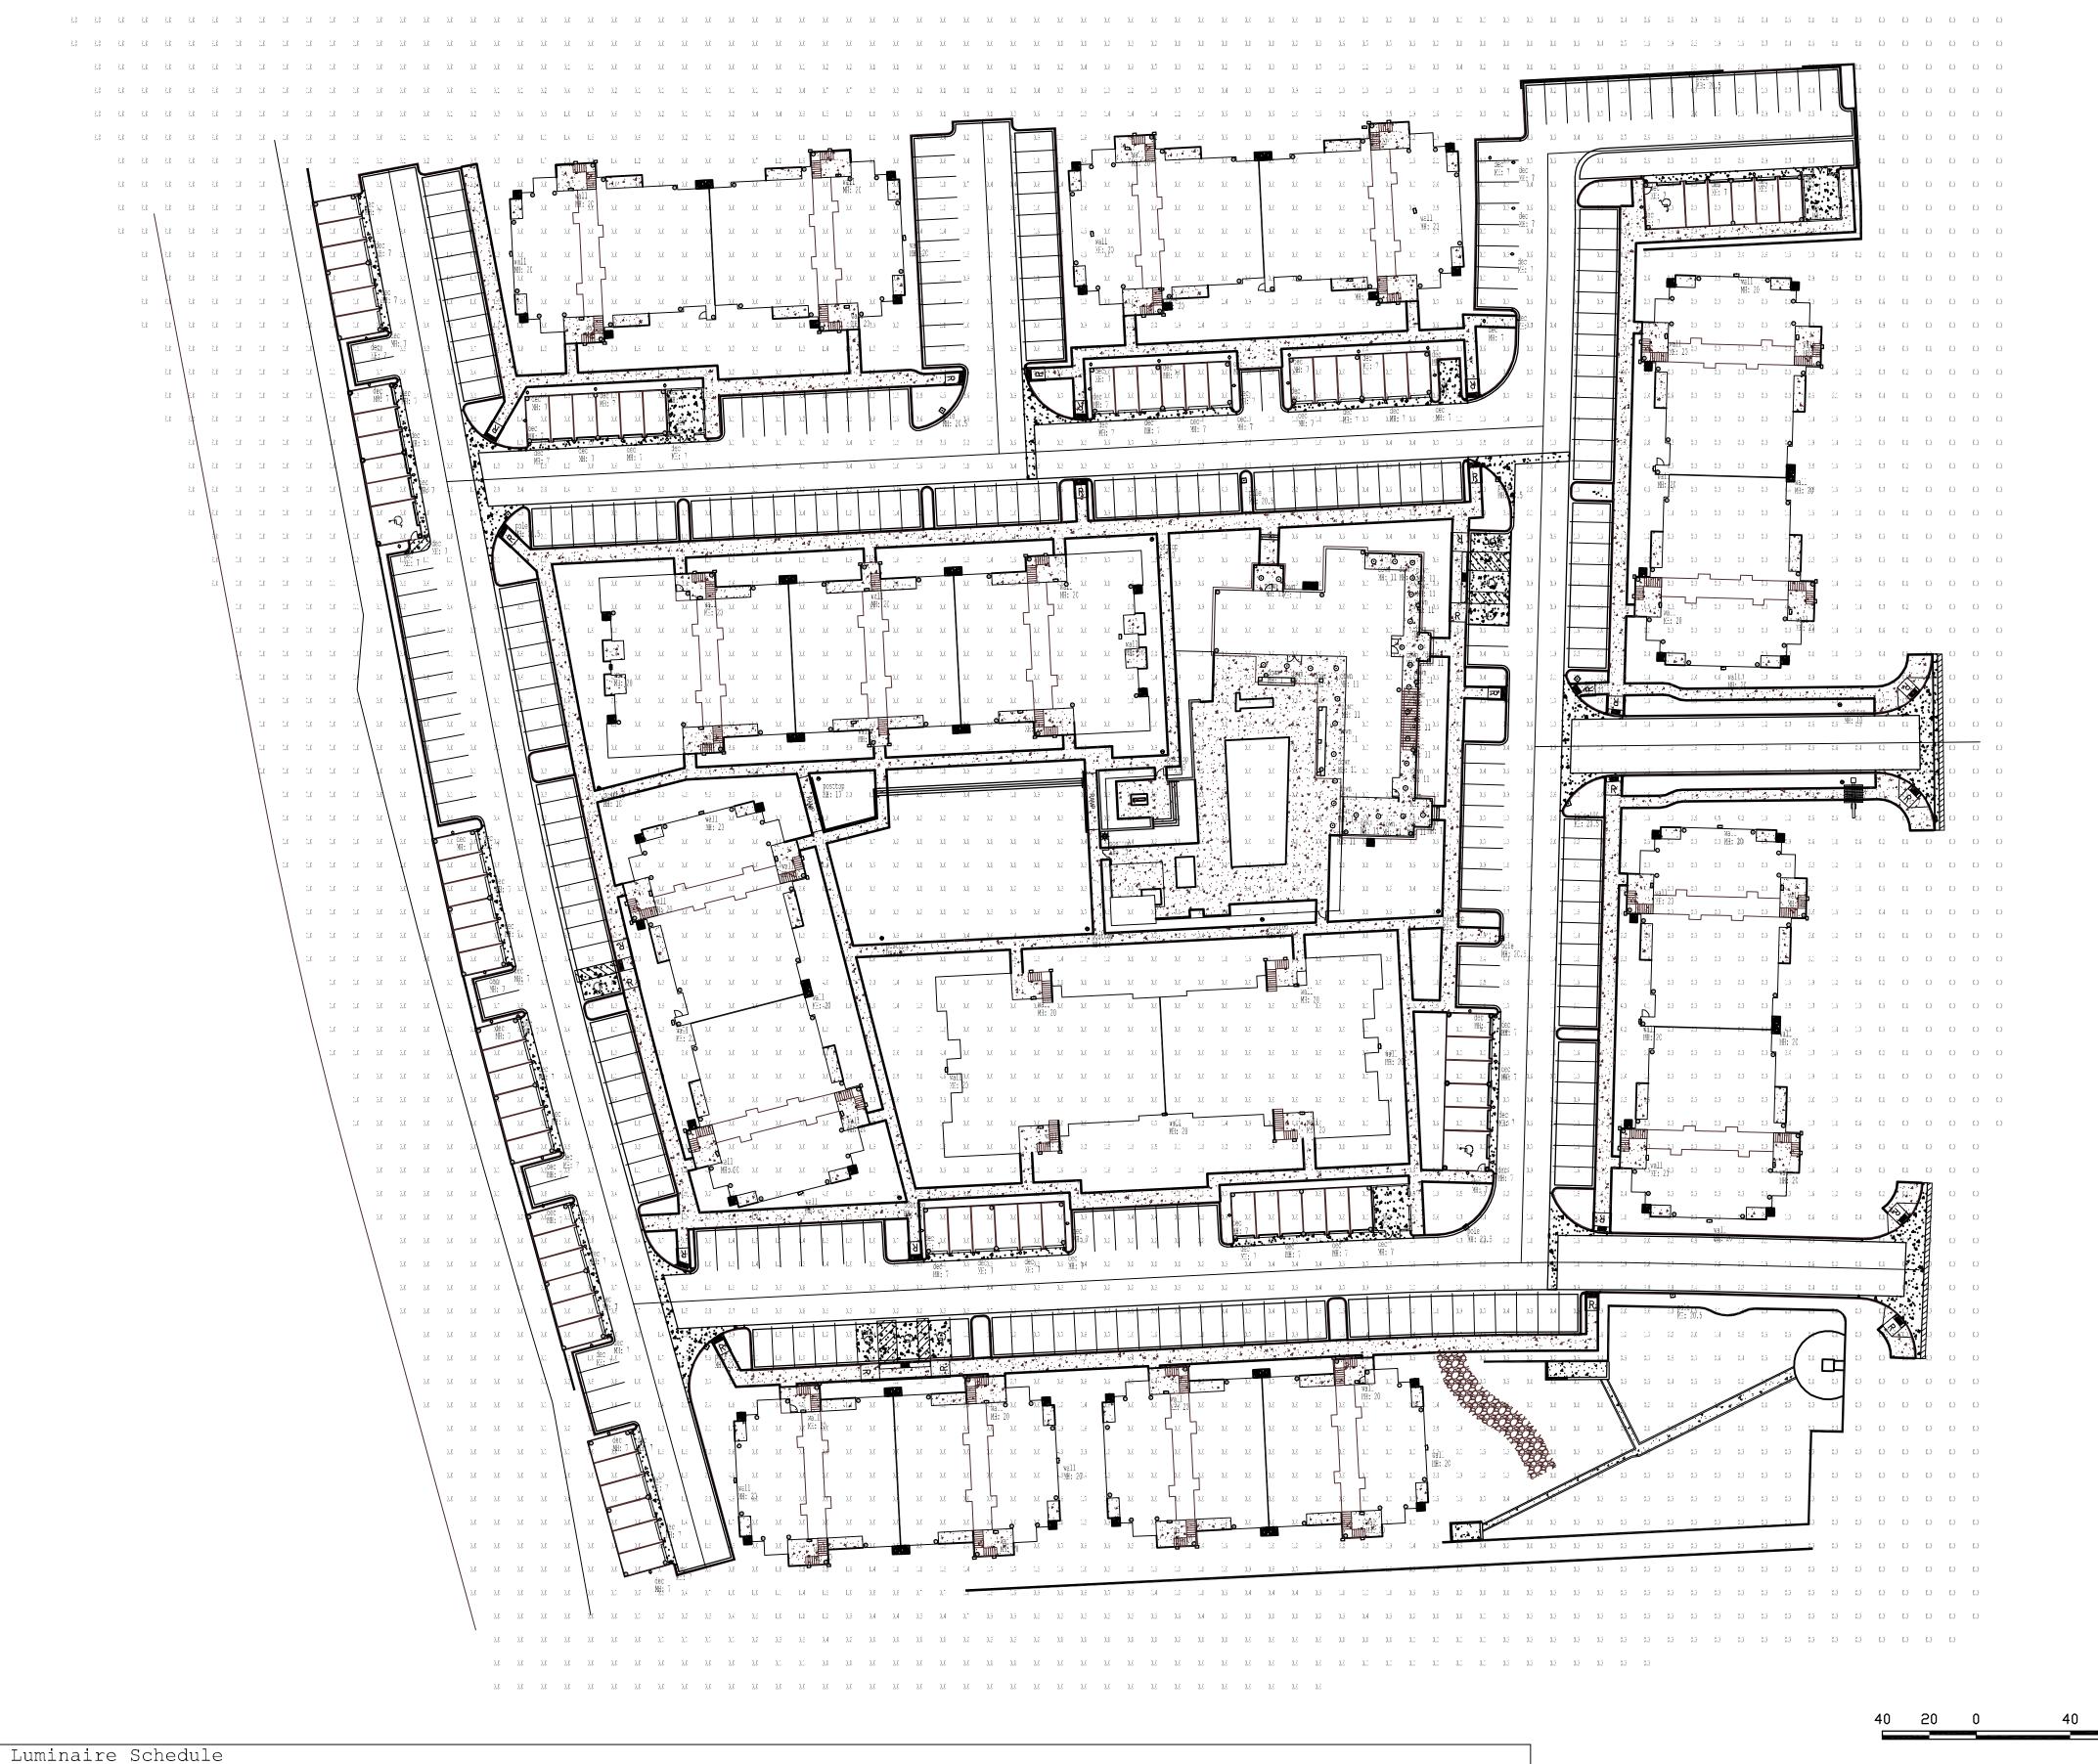Lumens

600

600

12800

15000

1490

8500

Description

1.000 decorative entry light - 13w compact fluorescent

recessed downlight - 13w compact fluorescent

spaulding nite torch - type 5- 150w incandescant

lsi chalenger wall pack - forward throw - 175w metal halide

lsi citation pole mounted light - type 3 - 175 w metal halide

lsi citation pole mounted light - type 3 - 100 w metal halide

to to to to to to

SCALE: 1" = 40'

DESIGNATES FIXTURE IDENTIFIER

➤DENOTES MOUNTING HEIGHT OF FIXTURE

ŊŊ

Symbol

Label

down

wall

pole

posttop

pole-100

dec

Qty

92

30

62

12

CHECKED BY: DRAWN BY:

ATTACHMENT 1

RESOLUTION 2013-08 NORTHGLENN PLANNING COMMISSION

RESOLUTION **PROVIDING FAVORABLE** \mathbf{A} A RECOMMENDATION CITY COUNCIL TO THE APPROVAL TO THE STONE MOUNTAIN - PHASE II PRELIMINARY PLANNED UNIT DEVELOPMENT (PUD) AND APPROVAL OF THE FINAL PLANNED UNIT DEVELOPMENT

WHEREAS, Northglenn Ordinance 11-37-2 requires that the Northglenn Planning Commission review and make recommendation to Council any application for rezoning; and

WHEREAS, the Northglenn Planning Commission therefore desires to make its recommendations to the City Council as required by law.

WHEREAS, the Planning Commission has found that the application satisfies the applicable criteria for rezoning and PUD criteria under 11-37-2 & 11-16-2 for purposes of approving the Final Planned Unit Development respectively;

BE IT RESOLVED BY THE PLANNING COMMISSION OF THE CITY OF NORTHGLENN, COLORADO, THAT:

- The City of Northglenn Planning Commission hereby provides a Section 1. favorable recommendation to the City Council for approval of the Stone Mountain Preliminary PUD in accordance with the proposed Ordinance for adoption.
- Section 2. The City of Northglenn Planning Commission hereby recommends that the following conditions shall be met prior to recordation of the PUD with the Adams County Clerk and Recorder, as required by law.
 - 1. The applicant shall enter into a Subdivision Improvement Agreement, with the City of Northglenn, that will be recorded with the Adam's County Clerk and Recorder's Office, to memorialize the public improvements shown in the PUD plans.

DATED this day of	, 2013
	Sonia Di Carlo
	Planning Commission Chair
ATTEST:	
Travis Reynolds Secretary	_

ATTACHMENT 2

Case No. Z-3-12 Applicant: Holland Partner Group

Location: 11525 Community Center Drive

Ordinance: 11-16 and 11-37-2

STONE MOUNTAIN II PRELIMINARY & FINAL PLANNED UNIT DEVELOPMENT (PUD) AMENDMENT STAFF REPORT AND RECOMMENDATION

REQUEST:

The applicant, Holland Partners (owner), requests the Planning Commission hear and recommend, to the City Council, an amendment to the existing Planned Unit Development zoning of the parcel located at 11525 Community Center Drive (Exhibit A).

REASON FOR REQUEST:

The applicant proposes to amend an existing multi-family residential PUD in order to develop a 228 unit multi-family project.

BACKGROUND:

The site was zoned PUD for 188 residential units as a secondary phase of the initial Stone Mountain I development in 2000. The proposal at the time called for 9 structures, 42 garage spaces, and an area for a future clubhouse/community center. The original development was never realized and the current owner is requesting modification of the PUD to increase the number of units to 228. The site consists of approximately 9.0 Acres (Exhibit B).

The applicant has requested that the Planning Commission hear and make recommendation on the Preliminary PUD and also hear and approve the Final PUD (contingent upon City Council approving the Preliminary PUD) during this hearing. If the Planning Commission makes a recommendation on the Preliminary PUD and approves the Final PUD, the recommendation will be forwarded to the City Council for approval. If City Council approves the rezoning, the PUD will be approved to obtain a development permit. Under this scenario the last step for this application will be City Council approval.

The Planning Commission must provide a recommendation of the Preliminary PUD and any decision of the Final PUD based on the criteria from Sections 11-16-2 and 11-37-2 of the Northglenn Zoning Ordinance, outlined in the Approval Criteria Section below.

SURROUNDING LAND USES:

North: Residential PUD (Stone Mountain Phase I)
South: C-5 Commercial (Boondocks Fun Center)

West: Interstate 25

East: Multi-Family Residential

CASE ANALYSIS:

The analysis of the case was completed with the review of submitted materials for the Preliminary PUD and Final PUD.

Land Use / Site Plan

The Stone Mountain II proposal is a modification of a previously approved multi-family PUD approved in 2000. Information submitted for the Preliminary and Final PUD depicts Nine (9) individual multi-family buildings, one (1) community clubhouse, and 14 garage structures for covered parking. The nine multi-family structures encompass 228 dwelling units organized as follows in Table 1.

Unit Type	No. of Units	Percent of all units
One-bedroom Jr.	90	39%
One-bedroom	48	21%
Two-bedroom	72	32%
Three-bedroom	18	8%

Setbacks

Setbacks for all structures are proposed per the following table:

Setback	Dimension		
Front	25′		
Side	15′		
Rear	60′		
Rear - Accessory	5'		

Section 11-34-3(b) Noise Barrier Fencing requires the installation of noise reducing fencing or a 100' setback of all units from the extents of a State Highway. The geography of the site places the development nearly 20 feet below the grade of Interstate 25. Based on the grade change, noise barrier fencing will provide little to no noise cancelling function. The proposal depicts minimal encroachment of buildings into the 100' setback for noise reduction. One structure encroaches approximately 30' into the 100' setback. This building was moved to this location

to accommodate staff's request for changes to the stormwater detention facility. Further, this structure is adjacent to one of the fourteen proposed garages that is approximately 14' at its peak and will act as noise buffering for the bottom two floors.

Traffic

The applicant initiated an updated traffic study to understand the impacts to the surrounding road network. The review extent of the study took into consideration the potentially impacted road network and intersections at the following locations:

- 120th & Grant
- Comm. Center Drive and Malley
- Comm. Center Drive and Huron Street

The study found that no additional mitigation measures were required to offset the traffic impacts. Staff concurs with these findings.

Parking

The applicant is requesting a reduced, on-site parking ratio as compared to the standard provided by the zoning ordinance. In support of this request, the applicant submitted a parking study outlining contemporary standards adopted by other regional jurisdictions and standards supported by national urban planning resources (**Exhibit C**). Staff concurs with the recommendations of the study and supports the proposed ratio as adequate and functional for the development. The staff bases their findings on the following:

- A generic 2.0 standard spaces per unit does not adequately account for the mix of unittypes and associated parking demand. The majority (60%) of the proposed units are classified as one bedroom, often requiring fewer parking spaces.
- The proposed project is within a 0.7 mile walk of the RTD Wagon Road Park-n-Ride This proximity may help offset parking demand.
- The appropriate number of parking spaces will reduce the amount of impervious surface associated with the project, thus, reducing the impact to an already taxed City stormwater system.
- Fewer onsite parking spaces will generate fewer trips and impacts on the roadway system.

Drainage

The proposed project site will detain stormwater flows, in accordance with City standards, in a proposed detention facility prior to releasing to the City's stormwater system. Additionally, stormwaters that have historically flowed through the site from the west side of the I-25 will now be piped to the southern extent of the site and will enter the City's stormwater system near the SE corner of the site.

Elevations

Elevations are included with the Final PUD. The primary materials are shown as cementitious lap siding and stone veneer in various colors. These different materials create a variation in the elevations that comply with the standard architectural requirements outlined in section 11-19-5(a) (1) & (2).

Landscaping

Total landscape area equates to 26% of the site. On-site and street trees are in excess of requirements provided by the landscape ordinance. No prohibited species are proposed.

Administration

In accordance with 11-16-6 Approval Criteria, staff has found that the proposal for the Preliminary and Final PUD is in conformity with the Northglenn Zoning Ordinance and Comprehensive Plan. Any civil infrastructure impacts have been properly mitigated.

The North Metro Fire Rescue District has reviewed the submitted plans and has no objections to the proposal. At time of construction the applicant will be required to meet all code requirements of the North Metro Fire Rescue District and the City of Northglenn's Chief Building Official.

Property owners surrounding the proposed facility were notified via mail of the proposal, as required by Section 11-41-3(a) of the City's Zoning Ordinance. In addition, the property in question was posted as required by Section 11-41-3(b).

APPROVAL CRITERIA:

Section 11-16-6-Approval Criteria:

(a) Prior to granting approval for any preliminary or final planned unit development plan, the Planning Commission and City Council shall give consideration to the purpose and intent of this Article 16 as listed in Section 11-16-2, above, and those criteria for any rezoning request as listed in Section 11-37-2(h) of this Chapter 11 of the Municipal Code. In addition, prior to approval of any final planned unit development plans, the Planning Commission shall find them to be in conformity with the approved preliminary planned unit development plans.

Section 11-16-2 reads as follows:

"Section 11-16-2. Purpose and Intent.

- (a) The purpose and intent of this Article is to create a Planned Unit Development regulation which will maximize the land resources available within the City of Northglenn. More specifically, the purposes are as follows:
 - (1) To ensure that zoning decisions are directed toward achievement of community goals and objectives, as embodied in the adopted Master Development Plan, rather than satisfying arbitrary minimum standards.
 - (2) To recognize the unique nature of each parcel of land and allow flexibility in the planning and design response.
 - (3) To encourage and promote innovation in land development by allowing more variety in type, design, layout, and architectural design of buildings and site amenities.
 - (4) To ensure that proposed rezonings and specific proposals presented to staff and the Planning Commission are constructed as presented and not used merely as a tool to facilitate property sale or some other transfer of real estate to make it more marketable.
 - (5) To encourage economic development to expand the City's tax base and provide employment opportunities.
 - (6) To create a PUD ordinance that streamlines, consolidates and simplifies zoning and subdivision, an ordinance that expedites rather than hinders the development process.
 - (7) To allow for the preservation of natural site amenities such as mature trees, water bodies and channels, exceptional views, etc.
 - (8) To promote the judicious use of open space and landscaped areas with regard to utility and visual impact.
 - (9) To encourage a harmonious and integrated mix of land uses and require compatibility between new and existing development.
 - (10) To provide for the efficient and safe movement of vehicular and pedestrian traffic on both public and private roadways. "

Additionally;

Section 11-37-2-Zone Changes

- (h) Basis for Approval. The Commission and Council shall give consideration to and satisfy themselves to the following:
 - (1) That a need exists for the proposal;

- (2) That this particular parcel of ground is indeed the correct site for the proposed development;
- (3) That there has been an error in the original zoning; or
- (4) That there have been significant changes in the area to warrant a zone change;
- (5) That adequate circulation exists and traffic movement would not be impeded by development; and
- (6) That additional municipal service costs will not be incurred which the City is not prepared to meet.

APPROVAL CRITERIA ANALYSIS

- (1) That a need exists for the proposal
 - Staff finds that the project located on this otherwise underutilized site will generate activity and provide varying housing options in this space that that has been entitled since 2000.
- (2) That this particular parcel of ground is indeed the correct site for the proposed development;
 - Staff finds the proposed development is appropriate for this site and is the second phase of a planned and approved two phase development. The applicant initiated updated traffic, parking, utility, and drainage studies that depicted the existing systems could adequately handle proposed impacts.
- (3) That there has been an error in the original zoning; or Staff finds that this criteria is not applicable as this proposal is an amendment to the existing approved PUD for the same type of land use.
- (4) That there have been significant changes in the area to warrant a zone change;

 The site has been entitled for multi-family development since 2000. No changes have occurred in the area that would warrant deviation from the planned use in that location. The applicant is intensifying the use slightly and therefore a PUD amendment process was prescribed.
- (5) That adequate circulation exists and traffic movement would not be impeded by development; and
 - The applicant initiated an updated traffic study that depicts that the existing road network can adequately handle the proposed impacts.
- (6) That additional municipal service costs will not be incurred which the City is not prepared to meet.
 - Staff finds that there will be no additional municipal service costs incurred.

COMMISSION OPTIONS:

The Planning Commission is making a recommendation for Preliminary PUD to the City Council and a final approval decision regarding the Final PUD. The Commissions options are as follows:

- 1) Approve the request, with or without conditions or stipulations;
- 2) Deny the request for reasons stated; or
- 3) Table the request for further consideration.

STAFF RECOMMENDATION:

Staff recommends a recommendation of the Preliminary PUD to the City Council and approval of the Final PUD with the following condition and based on six recommended Findings of Fact per the criteria of Section 11-37-2 of the Northglenn Zoning Ordinance as outlined in Planning Commission Resolution 13-8.

RECOMMENDED CONDITIONS OF APPROVAL:

The applicant shall enter into a Subdivision Improvement Agreement, with the City of Northglenn, recorded with the Adam's County Assessor's Office, to memorialize the public improvements shown in the PUD plans.

RECOMMENDED FINDINGS OF FACT:

The application is in compliance with the criteria outlined in section 11-37-2.

RESPECTFULLY SUBMITT	ED:	
Travis Reynolds, AICP Senior Planner		

WHAT'S NEXT: This is the final step in the entitlement process for the rezoning of the property.

FUTURE APPLICATIONS:

Preliminary PUD approved by City Council
 Building Permits approved administratively by staff



BENCHMARK:

ELEVATIONS ARE BASED ON NATIONAL GEODETIC SURVEY CONTROL POINT "S 411" LOCATED APPROXIMATELY 2 MILES WEST OF THE SITE ON FEDERAL BLVD. 1,500' SOUTH OF W. 120TH AVE NAVD 88 ELEVATION IS 5285.50'. THE SITE BENCHMARK IS A #5 REBAR, 18" LONG WITH 1-1/4" GREEN PLASTIC CAP STAMPED "CONTROL POINT" NAVD 88 ELEVATION =5423.78. LOCATED 47' EAST OF THE NORTHEAST CORNER OF THE SITE, AS SHOWN HEREON.

BASIS OF BEARINGS:

BEARINGS ARE BASED ON THE NORTH LINE LOT 1, STONE MOUNTAIN SUBDIVISION, FILING NO. 2, AS MONUMENTED BY NUMBER 5 REBARS WITH 1-1/4" YELLOW PLASTIC CAPS, PLS 10945 AT BOTH ENDS AS BEARING S87°06'40"W AS SHOWN ON STONE MOUNTAIN SUBDIVISION, FILING NO. 2.

CONSTRUCTION SCHEDULE:

IT IS ANTICIPATED THAT CONSTRUCTION WILL START IN THE MIDDLE OF 2013, AND BE COMPLETED

THE CITY OF NORTHGLENN RESERVES THE RIGHT TO PERIODICALLY REVIEW THIS P.U.D. FOR CONFORMANCE WITH ITS PROPOSED CONSTRUCTION SCHEDULE AND, WHEN APPROPRIATE, REZONE THIS PROPERTY TO A DIFFERENT ZONING CLASSIFICATION.

LANDUSE:

ALL USES ALLOWED IN ANY RESIDENTIAL R-3 ZONE DISTRICT OF THE CITY OF NORTHGLENN.

ENGINEER CERTIFICATION

I HEREBY CERTIFY THAT THESE PLANNED UNIT DEVELOPMENT (P.U.D.) DOCUMENTS FOR **STONE** MOUNTAIN — PHASE II WERE PREPARED BY ME (OR UNDER MY DIRECT SUPERVISION) IN ACCORDANCE WITH THE CITY OF NORTHGLENN DESIGN AND CONSTRUCTION STANDARDS.

REGISTERED PROFESSIONAL ENGINEER STATE OF COLORADO NO. 43327

LAND USE SUMMARY				
LAND USE	PROPOSED			
SITE				
SITE AREA (GROSS):	392,230 SF / 9.00 AC			
DWELLING UNITS:	228 DU'S			
GARAGES:	13 DETACHED GARAGES			
DWELLING UNITS PER ACRE:	25.3 DU/AC			
BUILDING CODE:	2009 IBC			
OCCUPANCY CLASSIFICATION (APTS):	R2			
OCCUPANCY CLASSIFICATION (GARAGES):	U			
DEVELOPMENT PROPOSAL				
ALLOWED USES:	MULTI-FAMILY RESIDENTIAL			
LOT COVERAGE - BUILDING:	108,159 SF = 28%			
LOT COVERAGE - PAVING:	175,634 SF = 46%			
LOT COVERAGE - OPEN AREA:	101,103 SF = 26%			
LOT COVERAGE - TOTAL:	283,793 SF = 74%			
LANDSCAPE AREA:	101, 103 SF = 26%			
FRONT YARD SETBACK:	25 FT MIN			
SIDE YARD SETBACK:	15 FT MIN			
REAR YARD SETBACK (ACCESSORY BLDG):	5 FT MIN			
REAR YARD SETBACK (PRINCIPAL BLDG):	60 FT MIN			
MINIMUM LOT AREA PER UNIT:	1,720 FT MIN			
BUILDING HEIGHT:	42 FT			

		OT INTO IT OF IT INCOME		100111		
	ITEM NO.	ITEM	QUANTITY	UNIT	UNIT COST	TOTAL COST
	1	8" PVC WATER	1910	ĻF	\$55.00	\$105,050.00
	2	1" WATER METER	1	EA	\$8,000.00	\$8,000.00
	3	2" WATER METER	9	EΑ	\$12,500.00	\$112,500.00
	4	6" DIP FIRE HYDRANT LINE	125	LF	\$85.00	\$10.625 00
	5	FIRE HYDRANT ASSEMBLY	6	EA	\$5,500.00	\$33,000.00
	6	4" GATE VALVE	9	EΑ	\$2,000.00	\$18,000.00
	7	6" GATE VALVE	6	EA	\$2,500.00	\$15,000.00
	8	8" GATE VALVE	10	EA	\$2,800.00	\$28,000.00
	9	8"X4" TEE	9	EA	\$2,900.00	\$26,100.00
	10	8"X6" TEE	6	EA	\$3,200.00	\$19,200 00
	11	8"X8" TEE	3	EA	\$3,500.00	\$10,500.00
	12	8" ~ 11.25-DEGREE BEND	11	EΑ	\$550.00	\$6,050.00
	13	8" ~ 45-DEGREE BEND	11	EΑ	\$750.00	\$8,250.00
	14	8" PVC SANITARY	1092	LF	\$40.00	\$43,680.00
	15	4' INSIDE DIAMETER MANHOLE	8	EA	\$4,500.00	
	17	18" RCP STORM SEWER	409	LF	\$69.00	\$28,221.00
	18	24" RCP STORM SEWER	1422	LF	\$93.00	
	19	30" RCP STORM SEWER	127	LF	\$114.00	
	20	36" RCP STORM SEWER	104	LF	\$134.00	
	21	34" x 53" RCP STORM SEWER	76	LF	\$158.00	
	22	DETENTION POND OUTLET STRUCTURE		EA	\$10,000.00	
	23	HEADWALL W/ ORIFICE PLATE	1	EA	\$3,000.00	
	24	INLET TYPE C	2	EA	\$3,000.00	
	25	INLET TYPE 13	1	EA	\$4,250.00	
	26	INLET MODIFIED DOUBLE TYPE 13	2	EA	\$8,500.00	ı
	27	INLET MODIFIED TRIPLE TYPE 13	1	EA	\$12,750.00	
	28	INLET TYPE R 5'	1	EA	\$4,000.00	
	29	5' INSIDE DIAMETER MANHOLE	10	EA	\$5,100.00	
	30	6' INSIDE DIAMETER MANHOLE	3	EA	\$5,900.00	
		O MOIDE DIAMETER WARRIOLE			ψυ, σου. σο	Ψ17,700.00
	31	HANDIÇAP RAMPŞ	4	EA	\$1,250.00	\$5,000.00
	32	6" CURB AND GUTTER	88	LF	\$4.00	
	33	8' CROSSPAN	1214	SF	\$8.00	·
	34	SIDEWALK	675	SF	\$4.00	
 	35	ASPHALT PAVING	300	SF	\$2.50	
	35	ASFRALI FAVING	300	or_	\$2.50	φ/30.0c
	36	MOBILIZATION/GENERAL CONDITIONS	1	LS	\$5,000.00	\$5,000.00
	JQ	MOBILIZATION/GENERAL CONDITIONS		Lo	\$5,000.00	\$5,000.00
					SUBTOTAL	\$830,058.00
					15% CONTINGENCY	\$124,508.70
					TOTAL	\$954,566.70
					IOTAL	φ904,000.70

STONE MOUNTAIN PHASE II APARTMENTS PUBLIC IMPROVEMENTS


OPINION OF PROBABLE CONSTRUCTION COST

	PARKING SUMMARY	
	REQUIRED PARKING (SECTION 11-33-6, ZONING ORDINANCE)	PROVIDED PARKING
228-DU @ 2.0 SPACES/DU	456	343
SURFACE PARKING (OFF-STREET)		265 (257 STD, 7 HC)
DETACHED GARAGE PARKING	N/A	78 (75 STD, 3 HC)
TOTAL (OFF-STREET)	456 (2.00 SPACES/DU)	343 (1.50 SPACES/DU)
HANDICAP SUB-TOTALS		
HANDICAP GARAGE PARKING	N/A	3 STANDARD
HANDICAPPED	9 (TOTAL)	5 STANDARD, 2 VAN

STONE MOUNTAIN - PHASE II

SITUATED IN THE SOUTHWEST 1/4 OF SECTION 03, TOWNSHIP 02 SOUTH, RANGE 68 WEST OF THE 6TH P.M. CITY OF NORTHGLENN, COUNTY OF ADAMS, STATE OF COLORADO.

PRELIMINARY & FINAL PUD AMENDMENT

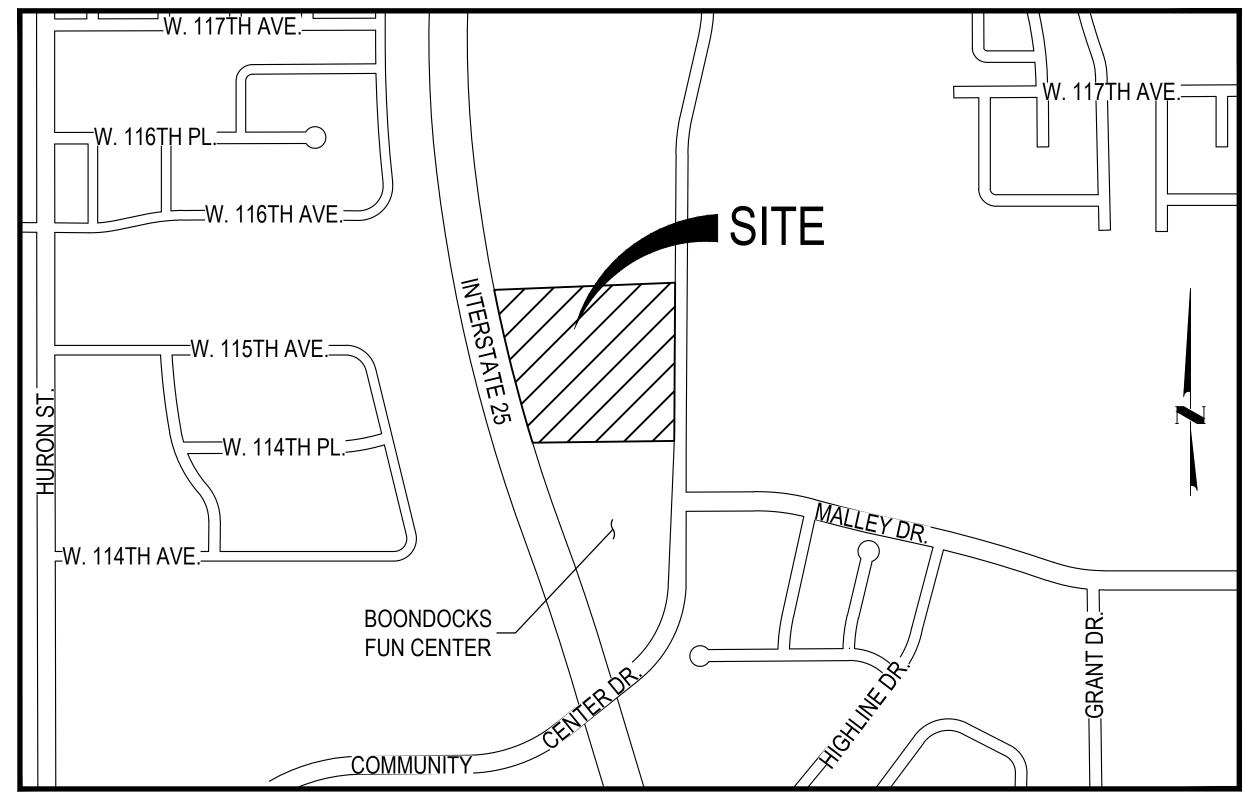

- 1. THE PUD AND INCLUDED INFORMATION SHALL ACT AS THE DESIGN GUIDELINES FOR
- THE DEVELOPMENT.
- MODIFICATION OF UP TO 10% OF ANY OF THE PERFORMANCE STANDARDS OUTLINED IN THE PUD MAY OCCUR ADMINISTRATIVELY PROVIDED THAT THE PROPOSED MODIFICATIONS MEET THE OVERALL DEVELOPMENT PATTERN, DESIGN INTENT, AND ARE SUPPORTED BY UPDATED, STAMPED, AND SEALED ENGINEERING STUDIES REFLECTING THE IMPACTS.

SHEET INDEX

- C.01 COVER SHEET
- C.02 SITE PLAN
- C.03 OVERALL GRADING PLAN C.04 OVERALL UTILITY PLAN
- A.01 EXTERIOR ELEVATIONS A.02 EXTERIOR ELEVATIONS
- A.03 EXTERIOR ELEVATIONS A.04 EXTERIOR ELEVATIONS
- A.05 EXTERIOR ELEVATIONS
- A.06 EXTERIOR ELEVATIONS
- A.07 EXTERIOR ELEVATIONS L.01 LANDSCAPE PLAN
- L.02 PLANT SCHEDULE AND NOTES
- L.03 LANDSCAPE DETAILS P.01 LIGHTING PLAN



HOLLAND PARTNER GROUP 600 South Cherry Street, Suite 700 Denver, Colorado 80246 P: 303-399-0840 F: 303-399-1397 www.hollandpartners.net/

LANDSCAPE ARCHITECT:



1101 Bannock Street Denver, Colorado 80204 P 303 892 1166 F 303.892.1186 www.norris-design.com

CIVIL ENGINEER:



ARCHITECT: ARCHITECTS 720 NW Davis 503,221,1121

Suite 300 503 221.2077 D

Portland OR 97209 www.lrsarchitects.com

APPROVALS:

APPROVED BY THE DIRECTOR OF PLANNING AND DEVELOPMENT

DIRECTOR OF PLANNING AND DEVELOPMENT APPROVED BY THE DIRECTOR OF PUBLIC WORKS & UTILITIES DIRECTOR OF PUBLIC WORKS AND UTILITIES THIS PLANNED UNIT DEVELOPMENT PLAN (P.U.D.) FOR STONE MOUNTAIN - PHASE II HAS BEEN APPROVED BY THE PLANNING COMMISSION OF THE CITY OF NORTHGLENN, COLORADO ON THE ______ DAY OF _____, ____ PLANNING COMMISSION FINAL PLANNED UNIT DEVELOPMENT PLAN

MAYOR, CITY OF NORTHGLENN

OWNER'S CERTIFICATE:

ATTESTED BY THE CITY CLERK

CITY CLERK

ADDRESS

EXECUTED THIS ______ DAY OF ______, ____ COUNTY OF _____ THE FOREGOING INSTRUMENT WAS ACKNOWLEDGED BEFORE ME THIS _____ DAY OF _____, _____, OF PROPOSED DEVELOPMENT WITNESS MY HAND AND SEAL MY COMMISSION EXPIRES __ NOTARY PUBLIC

ADAMS COUNTY CLERK AND RECORDERS CERTIFICATE:

STATE OF			
COUNTY OF	S.S. -		
	T WAS FILED FOR RECORD IN MY OF	 	

ADAMS COUNTY CLERK AND RECORDER

COVER SHEET

SHEET TITLE:

SHEET NUMBER: SHEET 1 OF 15



PRELIMINARY ON NORTHGLENN, COL STON

Owner:

HOLLAND PARTNERS 600 SOUTH CHERRY STREET SUITE 700 DENVER, CO 80246 303.399.0840 303.399.1397

DATE:

<u>LEGEND</u> 3-25-2013 5-31-2013 6-28-2013 ELECTRIC TRANSFORMER DETACHED GARAGE PARKING SPACE COUNT

OFF-STREET PARKING SPACE COUNT STREET LIGHT --- EXISTING FENCE

SCALE: 1"= 40'

GARAGE NUMBER DESIGNATED HANDICAP PARKING SPACE

ACCESSIBLE ROUTE

PROPOSED HANDRAIL

SHEET TITLE: SITE PLAN

> SHEET NUMBER: C.02 SHEET 2 OF 15

NOTES:

1. ALL RAMPS SHALL BE INSTALLED IN CONFORMANCE WITH ALL APPLICABLE LOCAL, STATE, AND/OR FEDERAL REGULATIONS AND STANDARDS, INCLUDING BUT NOT LIMITED TO, THE AMERICANS WITH DISABILITIES ACT (ADA), THE FAIR HOUSING ACT (FHA) AND THE AMERICAN NATIONAL STANDARDS INSTITUTE (ANSI).

2. ALL CURB RETURN RADII ARE 25' UNLESS OTHERWISE NOTED.



STONE MOUNTAIN - PHASE II

Owner:

HOLLAND PARTNERS
600 SOUTH CHERRY STREET
SUITE 700
DENVER, CO 80246

303.399.0840

303.399.1397

DATE:

3-25-2013 5-31-2013 6-28-2013

<u>LEGEND</u>

PROPOSED RETAINING WALL

RETAINING WALL HEIGHT

PROPOSED DOWNSPOUT

SCALE: 1"= 40'

PROPOSED STORM SEWER

---- PROPOSED LANDSCAPE DRAIN

= 5420 EXISTING CONTOURS

—5420 PROPOSED CONTOURS

6-28-2013

SHEET TITLE:

OVERALL
GRADING PLAN

SHEET NUMBER

SHEET NUMBER:

C.03

SHEET 3 OF 15

OTES:

- 1. ALL RAMPS SHALL BE INSTALLED IN CONFORMANCE WITH ALL APPLICABLE LOCAL, STATE, AND/OR FEDERAL REGULATIONS AND STANDARDS, INCLUDING BUT NOT LIMITED TO, THE AMERICANS WITH DISABILITIES ACT (ADA), THE FAIR HOUSING ACT (FHA) AND THE AMERICAN NATIONAL STANDARDS INSTITUTE (ANSI).
- 2. SIDEWALK CROSS-SLOPES SHALL NOT EXCEED 2%. LONGITUDINAL WALK SLOPES SHALL NOT EXCEED 5% EXCEPT WHERE RAMPS ARE SPECIFIED.



STONE MOUNTAIN - PHASE II PRELIMINARY & FINAL PUD AMENDMENT NORTHGLENN, COLORADO HOLLAND PARTNERS

Owner:

HOLLAND PARTNERS
600 SOUTH CHERRY STREET
SUITE 700
DENVER, CO 80246
303.399.0840
303.399.1397

DATE: 3-25-2013 5-31-2013 6-28-2013

5-31-2013 6-28-2013

SHEET TITLE:
OVERALL UTILITY
PLAN

SHEET NUMBER:

SHEET 4 OF 15

SCALE: 1"= 40'



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COLOR ELEVATIONS

SIDING, ASSOCIATED CORNER TRIM, VENTS AND DOWNSPOUTS. COLOR TO MATCH SW 6122

SIDING, ASSOCIATED CORNER TRIM, VENTS AND DOWNSPOUTS. COLOR TO MATCH SW 6165

SIDING, ASSOCIATED CORNER TRIM, VENTS AND DOWNSPOUTS. COLOR TO MATCH SW 7044 AMAZING

DACCOURD ATMIS COVARY DOWN IT IR NULL VOID LECTER VIT OF WHAT CHO IS OWN 611/09

SIDING, ASSOCIATED CORNER TRIM, VENTS AND DOWNSPOUTS. COLOR TO MATCH SW 6163

SIDING, ASSOCIATED CORNER TRIM, VENTS AND DOWNSPOUTS. COLOR TO MATCH SW 6244 NAVAL

MATICHUE WHITE ANTIQUE WHITE

AVAILABLE UPON REQUEST

PAINT LEGEND

PAINT ENTIRE BUILDING USING ONE COLOR SCHEME

COLOR SCHEME BUILDING LOCATIONS SELECTED BY OWNER

CAMELBACK

GRASSLAND

CONNECTED GRAY

OWNER: HOLLAND PARTNERS 600 SOUTH CHERRY STREET SUITE 700 **DENVER, CO 80246**

303.399.0840

303.399.1397

BLDG TYPE A1

DATE:

06/28/13

SHEET TITLE: **EXTERIOR ELEVATION**

SHEET NUMBER: A.01 SHEET 5 OF 15

BUILDING TYPE A1 - TYPICAL END ELEVATION

SCALE: 1/8"=1'-0"



2. BUILDING TYPE A1 - TYPICAL SIDE ELEVATION

SCALE: 1/8"=1'-0"

CHECKED BY: DRAWN BY:



BUILDING TYPE A2 - TYPICAL END ELEVATION SCALE: 1/8"=1'-0"



SEE BUILDING TYPE A1 FOR TYPICAL NOTES

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OWNER: HOLLAND PARTNERS 600 SOUTH CHERRY STREET SUITE 700 DENVER, CO 80246 303.399.0840 303.399.1397

BLDG TYPE A2

DATE:

06/28/13

SHEET TITLE: **EXTERIOR ELEVATION** SHEET NUMBER:

SHEET 6 OF 15



COLOR ELEVATIONS AVAILABLE UPON REQUEST PAINT LEGEND PAINT ENTIRE BUILDING USING ONE COLOR SCHEME COLOR SCHEME BUILDING LOCATIONS SELECTED BY OWNER SIDING, ASSOCIATED CORNER TRIM, VENTS AND DOWNSPOUTS. COLOR TO MATCH SW 6122 CAMELBACK SIDING, ASSOCIATED CORNER TRIM, VENTS AND DOWNSPOUTS. COLOR TO MATCH SW 6165 CONNECTED GRAY SIDING, ASSOCIATED CORNER TRIM, VENTS AND DOWNSPOUTS. COLOR TO MATCH SW 7044 AMAZING EP-4 WOOD FASCIA, DOOR AND WINDOW TRIM. COLOR TO MATCH SW 6119 ANTIQUE WHITE SIDING, ASSOCIATED CORNER TRIM, VENTS AND DOWNSPOUTS. COLOR TO MATCH SW 6163 EP-8

GRASSLAND

SIDING, ASSOCIATED CORNER TRIM, VENTS AND DOWNSPOUTS. COLOR TO MATCH SW 6244 NAVAL

SEE BUILDING TYPE A1 FOR TYPICAL NOTES

BUILDING TYPE A3 - TYPICAL END ELEVATION SCALE: 1/8"=1'-0"



SEE BUILDING TYPE A1 FOR TYPICAL NOTES

BUILDING TYPE A3 - TYPICAL SIDE ELEVATION

SCALE: 1/8"=1'-0"

CHECKED BY: DRAWN BY:

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OWNER: HOLLAND PARTNERS 600 SOUTH CHERRY STREET SUITE 700 DENVER, CO 80246 303.399.0840 303.399.1397

> BLDG TYPE A3

DATE: 06/28/13

SHEET TITLE: **EXTERIOR ELEVATION** SHEET NUMBER:

A.03 SHEET 7 OF 15



PAINT LEGEND

COLOR ELEVATIONS AVAILABLE UPON REQUEST

PAINT ENTIRE BUILDING USING ONE COLOR SCHEME COLOR SCHEME BUILDING LOCATIONS SELECTED BY OWNER

SIDING, ASSOCIATED CORNER TRIM, VENTS AND DOWNSPOUTS. COLOR TO MATCH SW 6122 CAMELBACK

SIDING, ASSOCIATED CORNER TRIM, VENTS AND DOWNSPOUTS. COLOR TO MATCH SW 6165 CONNECTED GRAY

SIDING, ASSOCIATED CORNER TRIM, VENTS AND

SIDING, ASSOCIATED CORNER TRIM, VENTS AND DOWNSPOUTS. COLOR TO MATCH SW 7044 AMAZING GRAY

EP-4

SEE EP-9

WOOD FASCIA, DOOR AND WINDOW TRIM. COLOR TO MATCH SW 6119 ANTIQUE WHITE

SIDING, ASSOCIATED CORNER TRIM, VENTS AND DOWNSPOUTS. COLOR TO MATCH SW 6163 GRASSLAND

SIDING, ASSOCIATED CORNER TRIM, VENTS AND DOWNSPOUTS. COLOR TO MATCH SW 6244 NAVAL

SEE BUILDING TYPE A1 FOR TYPICAL NOTES

1. BUILDING TYPE A4 - TYPICAL END ELEVATION

SCALE: 1/8"=1'-0'

CHECKED BY: DRAWN BY:



AIN - PHASE I

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OWNER:

HOLLAND PARTNERS
600 SOUTH CHERRY STREET
SUITE 700
DENVER, CO 80246
303.399.0840

303.399.1397

BLDG TYPE A4

DATE: 06/28/13

SHEET TITLE:

EXTERIOR

ELEVATION

SHEET NUMBER:

A.04 SHEET 8 OF 15



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TONE MOUNTAIN - PHASE II

OWNER:

HOLLAND PARTNERS
600 SOUTH CHERRY STREET
SUITE 700


DENVER, CO 80246 303.399.0840 303.399.1397

DATE: 06/28/13

SHEET TITLE:
EXTERIOR

SHEET NUMBER:
A.05
SHEET 9 OF 16

ELEVATION

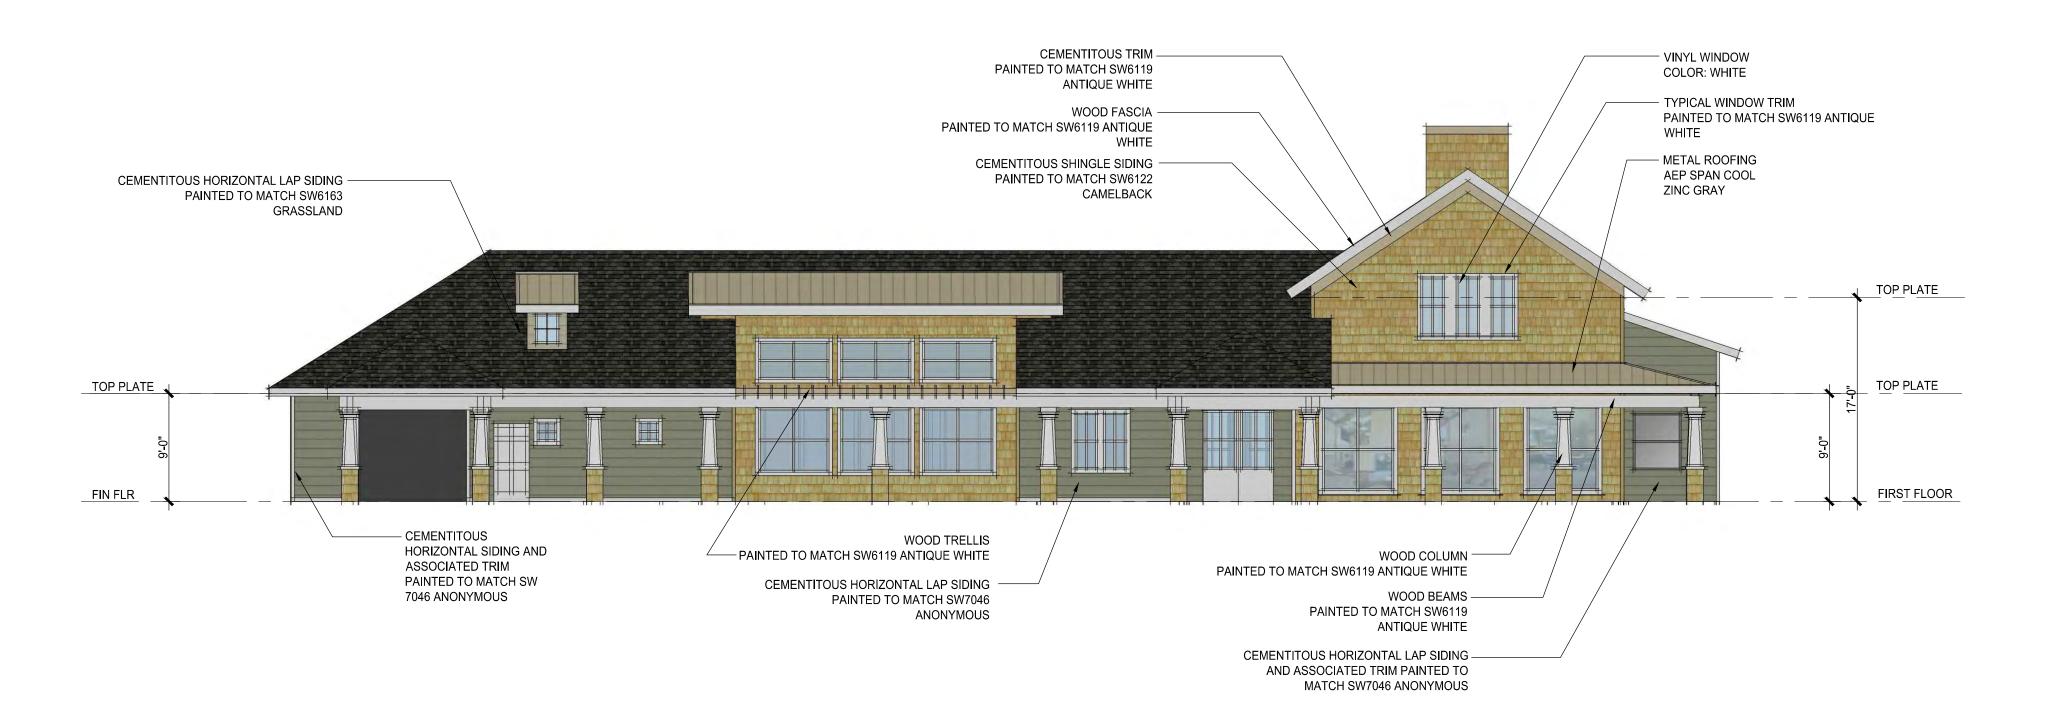

1. COMMUNITY BUILDING ELEVATION 1

SCALE: 1/8"=1'-0"



2. COMMUNITY BUILDING ELEVATION 2

SCALE: 1/8"=1'-0"



1101 Bannock Street Denver, Colorado 80204 P 303.892.1166 F 303.892.1186

OWNER: HOLLAND PARTNERS 600 SOUTH CHERRY STREET SUITE 700 DENVER, CO 80246 303.399.0840 303.399.1397

DATE:

06/28/13

SHEET TITLE: **EXTERIOR ELEVATION** SHEET NUMBER: A.06

SHEET 10 OF 15




1. COMMUNITY BUILDING BACK ELEVATION 1




2. COMMUNITY BUILDING BACK ELEVATION 2 SCALE: 1/8"=1'-0"

1. REAR ELEVATION

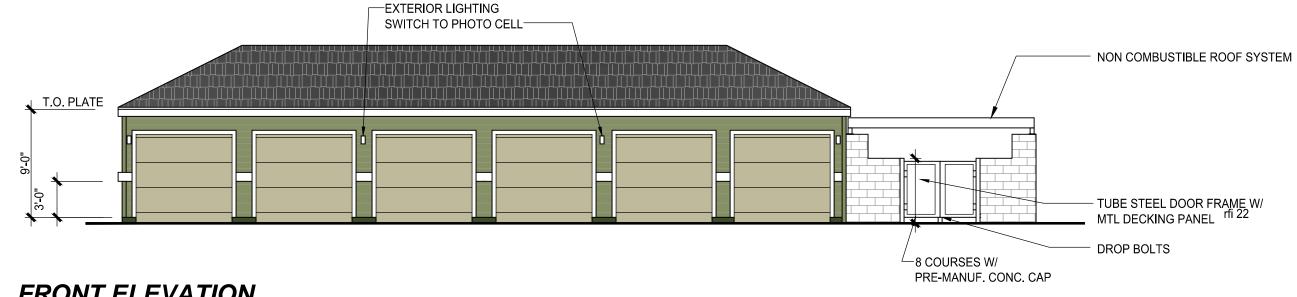


3. FRONT ELEVATION


SCALE: 1/8"=1'-0"

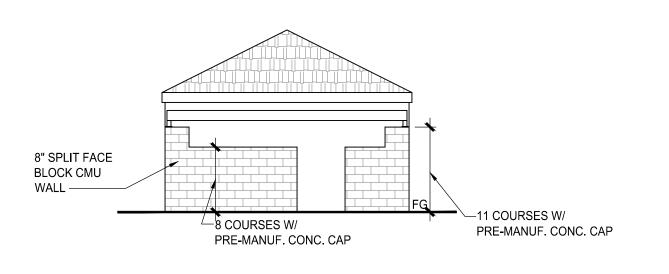


5. SIDE ELEVATION

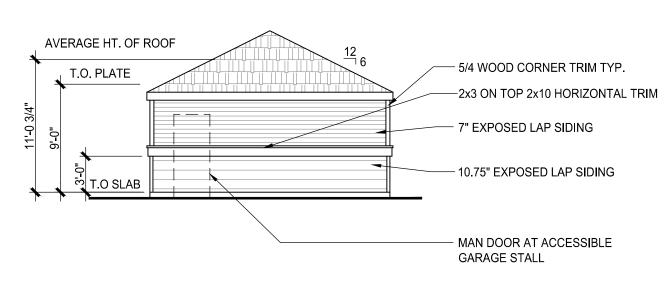


6. SIDE ELEVATION

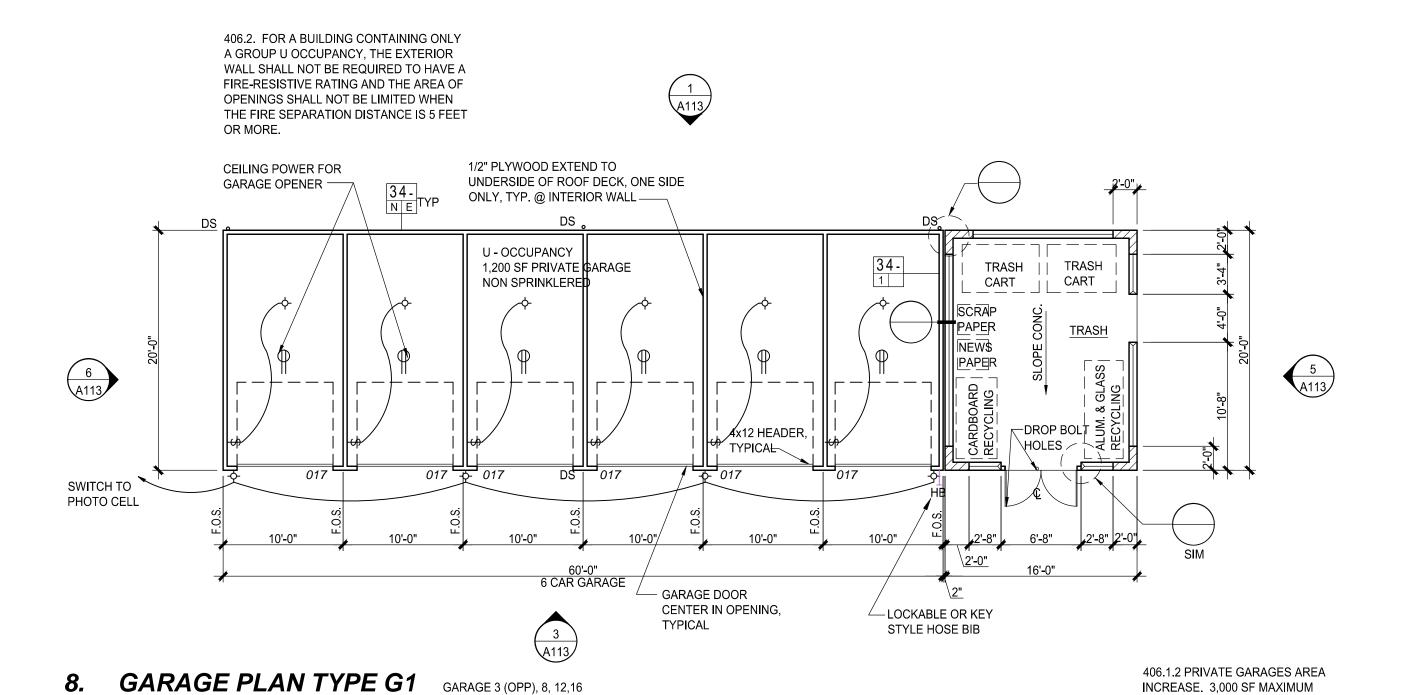

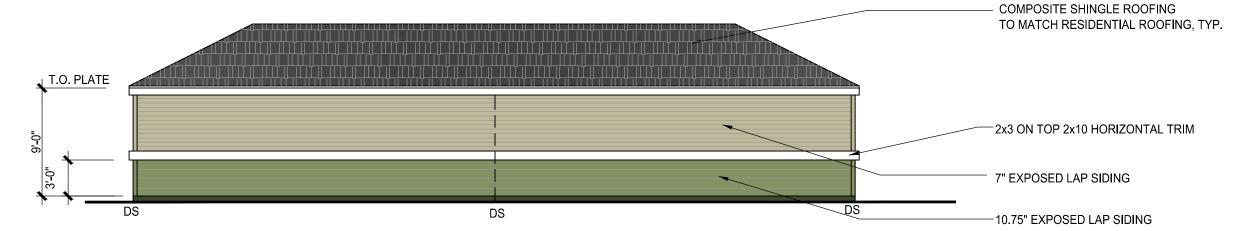


2. REAR ELEVATION SCALE: 1/8"=1'-0"

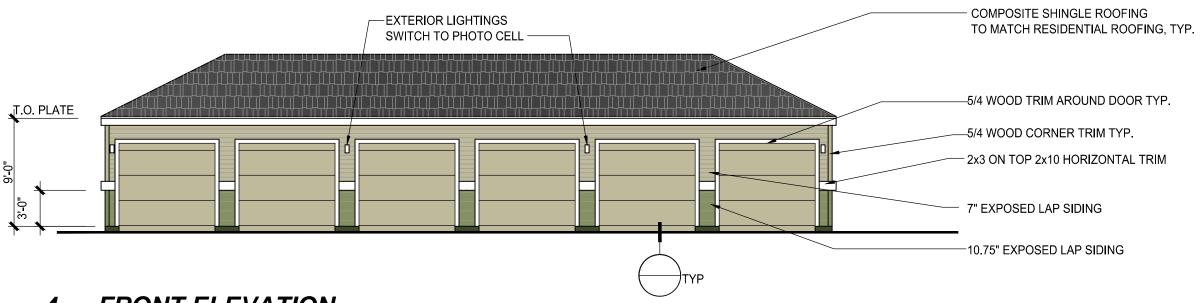


4. FRONT ELEVATION

SCALE: 1/8"=1'-0"

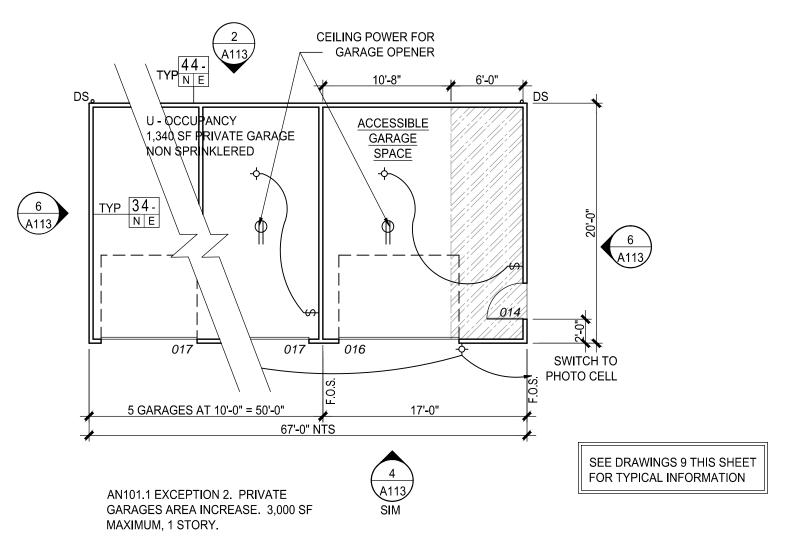

7. GARAGE ACCESSIBLE STALL PLAN TYPE G2

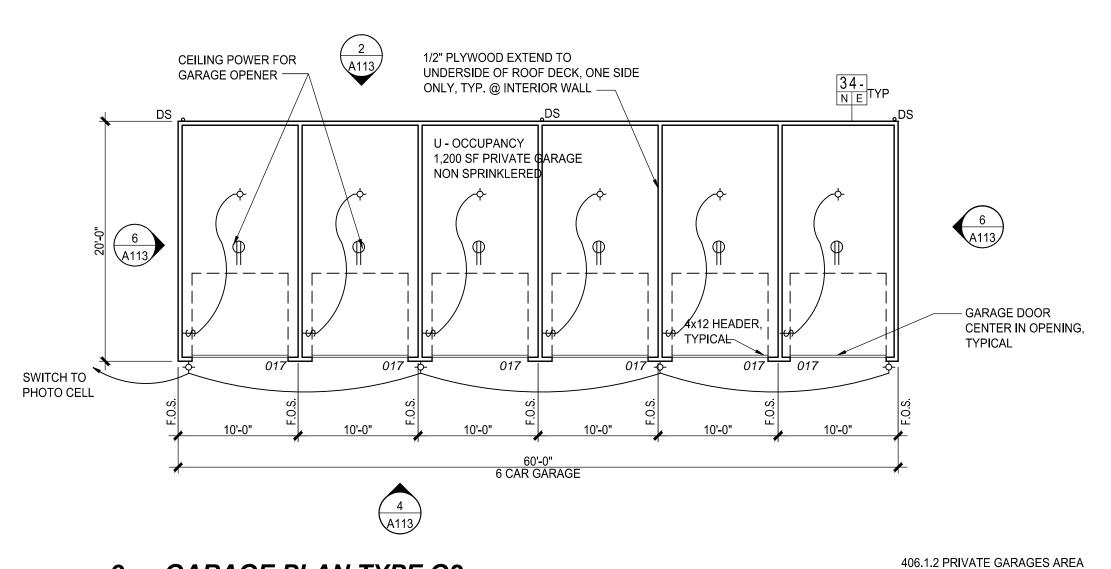

9. GARAGE PLAN TYPE G3 GARAGE 2, 4, 5, 6, 7, 9, 10, 11, 14, 15, 17, 18

INCREASE. 3,000 SF MAXIMUM

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303.399.1397

DATE: 06/28/13

SHEET TITLE: **EXTERIOR ELEVATION** SHEET NUMBER: **A.07** SHEET 11 OF 15



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F 303.892

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HOLLAND PARTNERS


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DATE:


03/29/2013

05/31/2013 06/28/2013

LEGEND

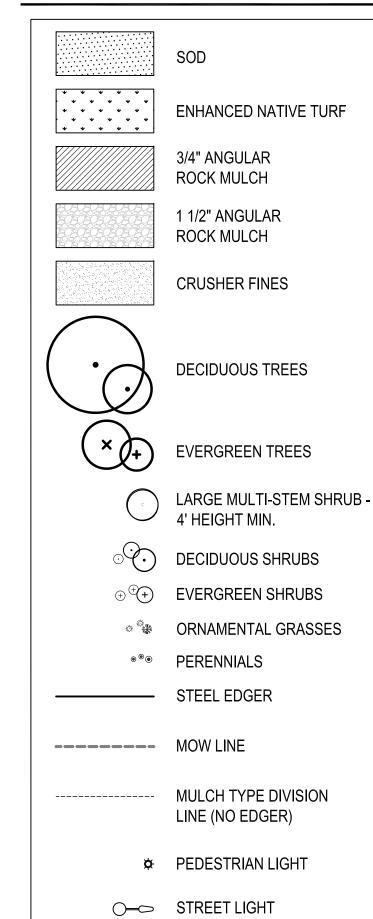

Know what's below.
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SHEET TITLE:
LANDSCAPE
PLAN
SHEET NUMBER:
L.01

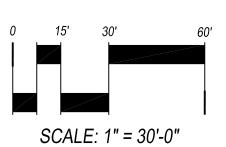SHEET 12 OF 15

LANDSCAPE NOTES:

- 1. ALL TREES ARE TO BE SECURELY GUYED FOR ONE YEAR PER DETAILS.
- 2. ALL SHRUB BEDS SHALL BE MULCHED WITH MIN. 3" DEPTH ROCK MULCH OVER GEOTEXTILE FABRIC.
- 3. ALL PLANTING BEDS ARE TO BE CONTAINED BY 4" 1/8" THICK PERFORATED GALVANIZED EDGER. EDGER IS NOT REQUIRED WHEN BED IS ADJACENT TO CURBS, WALLS, WALKS, OR CONCRETE PANS. EDGER SHALL BE KINK FREE AND SMOOTH FLOWING IN CURVED
- 4. ALL TREE PITS IN SODDED AREAS ARE TO RECEIVE A 2-1/2" DIA. 2-1/2 DEPTH SHREDDED CEDAR MULCH RING. NO EDGER OR WEED CONTROL FABRIC IS REQUIRED.
- 5. ALL IRRIGATION DEVELOPMENT IS TO BE UNDERGROUND, AUTOMATIC, AND PROVIDE 100% COVERAGE TO ALL AREAS.

PLANT SCHEDULE:

WATER USE	SYM.	COMMON NAME	BOTANICAL NAME	SIZE & COND.	QTY.		
XX DECIDUOUS CAN			ULMUS WILSONIANA 'PROSPECTOR'	2.5" CAL. B&B			
			TILIA CORDATA 'GREENSPIRE'	2.5" CAL. B&B			
xx			CATALPA SPECIOSA	2.5" CAL. B&B			
			CELTIS OCCIDENTALIS	2.5" CAL. B&B			
			GYMNOCLADUS DIOICUS 'ESPRESSO' QUERCUS RUBRA	2.5" CAL. B&B 2.5" CAL. B&B			
			FRAXINUS AMERICANA 'AUTUMN PURPLE'	2.5" CAL. B&B			
		SHADEMASTER HONEYLOCUST	GLEDITSIA TRIACANTHOS 'SHADEMASTER'	2.5" CAL. B&B			
			CLADRASTIS KENTUKEA	2.5" CAL. B&B 2.5" CAL. B&B			
		LANCELEAF COTTONWOOD 6' HEIGHT (UNLESS NOTED LARGER ON PLA	POPULUS X ACUMINATA N)	2.5 CAL. B&B			
			PINUS NIGRA	8' HT. B&B (LARGE SYMBOL)			
			PINUS PONDEROSA	8' HT. B&B (LARGE SYMBOL)			
			PICEA PUNGENS	6' HT. B&B (SMALL SYMBOL)			
			PINUS FLEXILIS PINUS EDULIS	6' HT. B&B (SMALL SYMBOL) 6' HT. B&B (SMALL SYMBOL)			
		SKYROCKET JUNIPER	JUNIPERUS VIRGINIANA 'SKYROCKET'	6' HT. B&B (VERY SMALL SYMBOL)			
DECIDUOUS ORN							
XX XX			PRUNUS CALLERYANA 'CHANTICLEER' QUERCUS 'CRIMSCHMIDT'	2.0" CAL. B&B 2.0" CAL. B&B			
			KOELREUTERIA PANICULATA	2.0" CAL. B&B			
x	RAD	RADIANT CRAB	MALUS X 'RADIANT'	2.0" CAL. B&B			
			MALUS X 'SPRING SNOW'	2.0" CAL. B&B			
			CRATAEGUS CRUSS-GALLI INERMIS	2.0" CAL. B&B 6'-8' HT. MULTISTEM B&B			
			AMELANCHIER X GRANDIFLORA ACER TATARICUM 'PATTERN PERFECT'	6'-8' HT. MULTISTEM B&B			
LARGE MULTI-ST							
			HIBISCUS SYRIACUS 'LAVENDER CHIFFON'	4' HT., B&B, MULTISTEM			
			PRUNUS CISTENA	4' HT., B&B, MULTISTEM 4' HT., B&B, MULTISTEM			
X EVERGREEN SHR		AUTUMN JAZZ VIBURNUM	VIBURNUM DENTATUM 'RALPH SENIOR'	H ΠΙ., DαD, WULTISTEM			
		OREGON GRAPE HOLLY 'KING'S RANSOM'	M. AQUIFOLIUM 'KINGS RANSOM'	#5 CONT.			
			EYONYMUS KIAUTSCHOVICA 'MANHATTAN'	#5 CONT.			
		ARMSTRONG JUNIPER	JUNIPERUS CHINENSIS "ARMSTRONG"	#5 CONT.			
			JUNIPERUS PROCUMBENS 'GREEN MOUND' PICEA PUNGENS 'GLOBOSA'	#5 CONT. #5 CONT.			
	1		ARCTOSTAPHYLOS 'PANCHITO'	#5 CONT.			
		COLOGREEN JUNIPER	JUNIPERUS SCOPULORUM 'COLOGREEN'	#5 CONT.			
			PINUS MUGO 'MOPS'	#5 CONT.			
			D. X BURKWOODI 'CAROL MACKIE' JUNIPERUS VIRGINIANA 'SKYROCKET'	#5 CONT. #5 CONT.			
			Y. FILAMENTOSA	#5 CONT.			
			PICEA PUNGENS 'R.H. MONTGOMERY'	#5 CONT.			
DECIDUOUS SHRI				Luc cont			
			BERBERIS THUNBERGII 'ATROPURPUREA NANA' CARAGANA PYGMAEA	#5 CONT. #5 CONT.			
		· · · · ·	RHAMNUS FRANGULA 'RON WILLIAMS'	#5 CONT.			
x	BDW	PURPLE HAZE BUTTERFLY BUSH	BUDDLEIA X 'PURPLE HAZE'	#5 CONT.			
XX			LIGUSTRUM VULGARE 'LODENSE'	#5 CONT.			
			SYMPHORICARPOS X CHENAULT 'HANCOCK' ROSA 'RADSUNNY' (YELLOW)	#5 CONT. #5 CONT.			
			ROSA 'RADRAZZ' (RED)	#5 CONT.			
xx	DRS	DWARF RUSSIAN SAGE	PEROVSKIA ARTIPLICIFOLIA 'LITTLE SPIRE'	#5 CONT.			
DECIDUOUS SHRI				Lyn cour			
			PHYSOCARPUS OPULIFOLIUS 'NANUS' CARYOPTERIS X CLANDONENSIS	#5 CONT. #5 CONT.			
			PRUNUS BESSEYI 'PAWNEE BUTTES'	#5 CONT.			
	YFC	YELLOW FLOWERING CURRANT	RIBES AUREUM	#5 CONT.			
		KOREAN SPICE VIBURNUM	VIBURNUM CARLESII	#5 CONT.			
			SYRINGA PATULA 'MISS KIM' CHRYSOTHAMNUS NAUSEOSUS ALBICAULIS	#5 CONT. #5 CONT.			
			RHUS TRILOBATA	#5 CONT.			
X			RIBES ALPINUM	#5 CONT.			
DECIDUOUS SHRI	$\overline{}$		CYDING A VIII CADIC	#5 CONT			
			SYRINGA VULGARIS CORNUS SERICIEA 'BAILEYI'	#5 CONT. #5 CONT.			
			CORNUS SERICEA 'FLAVIRAMEA'	#5 CONT.			
		NEW MEXICO PRIVET ALL GRASSES 1 GAL. CONT. UNLESS SPECIFI	FORESTIERA NEOMEXICANA ED OTHERWISE ON THE PLAN)	#5 CONT.			
	<u> </u>		HELICTOTRICHON SEMPERVIRENS	#1 CONT.			
			CALAMAGROSTIS ARUNDINACEA 'KARL FOERSTER'	#1 CONT.			
			MISCANTHUS SINENSIS 'GRACILLIMUS'	#1 CONT.			
X XXX			PENNISETUM SETACEUM 'RUBRUM' SCHIZACHYRIUM SCOPARIUM	#1 CONT. #1 CONT.			
			PANICUM VIRGATUM 'SHENANDOAH'	#1 CONT.			
		HARDY PLUME GRASS	ERIANTHUS RAVENNAE	#5 CONT.			
	PER	ALITUMNI IOV CEDUM	OFFILM IN LOVE	Let CONT			
		AUTUMN JOY SEDUM RED VALERIAN/JUPITER'S BEARD	SEDUM 'AUTUMN JOY' CENTRANTHUS RUBER	#1 CONT. #1 CONT.			
			AGASTACHE RUPESTRIS	#1 CONT.			
			G. LINDHEIMERI	#1 CONT.			
			LAVANDULA ANGUSTIFOLIA 'MUNSTEAD'	#1 CONT.			
			PERSICARIA AFFINIS RUDBECKIA FULGIDA 'GOLDSTRUM'	#1 CONT. #1 CONT.			
			HEMEROCALIS HYBRID	#1 CONT.			
			HEMEROCALIS 'STELLA D'ORO'	#1 CONT.			
			G. LINEARIS 'COLORADO GOLD'	#1 CONT.			
			DELOSPERMA FLORIBUNDA LIATRIS SPICATA 'KOBOLD'	#1 CONT. #1 CONT.			
			SALVIA SYLVESTRIS X 'MAY NIGHT'	#1 CONT.			
			ECHINACEA PURPUREA	#1 CONT.			
			ACHILLEA MILLEFOLIUM 'PAPRIKA'	#1 CONT.			
			HOSTA FORTUNEI 'PATRIOT' HEUCHERA MICRANTHA 'PURPLE PALACE'	#1 CONT. #1 CONT.			
			ARTEMESIA SCHMIDTIANA	#1 CONT.			



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03/29/2013 05/31/2013 06/28/2013	
	05/04/0040
06/28/2013	05/31/2013
	06/28/2013

SHEET TITLE: PLANT SCHEDULE & NOTES SHEET NUMBER:

L.02

SHEET 13 OF 15

Know what's below.

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— O.C. SPACING

1 SPECIFIED MULCH

AMENDED SOIL IN PLANTING BED (2) PER SPECIFICATIONS. TILL SOIL TO A DEPTH OF EIGHT INCHES.


(3) FINISH GRADE (TOP OF MULCH)

1. BROKEN OR CRUMBLING ROOT-BALLS WILL BE REJECTED

2. CARE SHOULD BE TAKEN NOT TO DAMAGE THE SHRUB OR ROOT-BALL WHEN REMOVING IT FROM ITS CONTAINER

3. ALL JUNIPERS SHOULD BE PLANTED SO THE TOP OF THE ROOT-BALL OCCURS ABOVE THE FINISH GRADE OF THE MULCH LAYER

4. DIG PLANT PIT TWICE AS WIDE AND HIGH AS THE CONTAINER

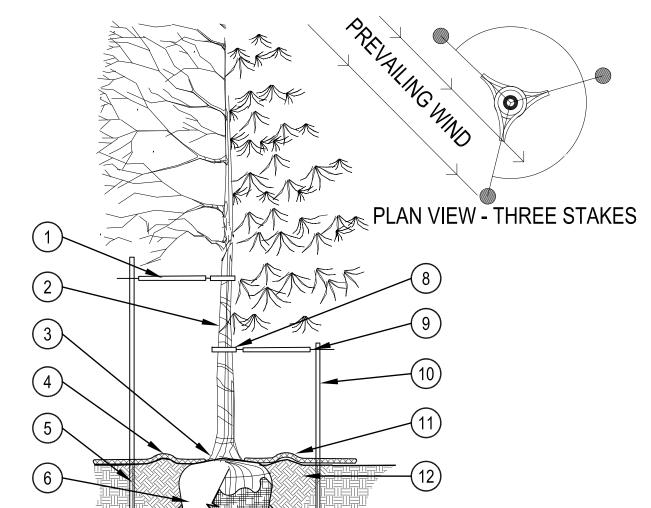

ROOT BALL DIAMETER

TREE PLANTING DETAIL

PRUNING NOTES:

ALL PRUNING SHALL COMPLY WITH ANSI A300 STANDARDS.

2. DO NOT HEAVILY PRUNE THE TREE AT PLANTING. PRUNE ONLY CROSSOVER LIMBS, CO-DOMINANT LEADERS AND BROKEN BRANCHES. SOME INTERIOR TWIGS AND LATERAL BRANCHES MAY BE PRUNED. HOWEVER, DO NOT REMOVE THE TERMINAL BUDS OF BRANCHES THAT EXTEND TO THE EDGE OF THE CROWN.

STAKING NOTES:

1. STAKE TREES PER FOLLOWING SCHEDULE, THEN REMOVE AT END OF FIRST GROWING SEASON. FOLLOWS:

 $1-\frac{1}{2}$ " CALIPER SIZE - MIN. 1 STAKE ON SIDE OF PREVAILING WIND (GENERALLY N.W. SIDE) $1-\frac{1}{2}$ " - 3" CALIPER SIZE - MIN. 2 STAKES - ONE ON N.W. SIDE, ONE ON S.W. SIDE (OR PREVAILING WIND SIDE AND 180° FROM THAT SIDE)

1.3 3" CALIPER SIZE AND LARGER - 3 STAKES PER DIAGRAM 2. WIRE OR CABLE SHALL BE MIN. 12 GAUGE, TIGHTEN WIRE OR CABLE ONLY ENOUGH TO KEEP FROM SLIPPING. ALLOW FOR SOME TRUNK MOVEMENT. NYLON STRAPS SHALL BE LONG ENOUGH TO ACCOMMODATE $1-\frac{1}{2}$ " OF GROWTH AND BUFFER ALL BRANCHES FROM WIRE.

1 PLACE MIN. 2" PVC PIPE AROUND 8 GROMMETED NYLON STRAPS EACH WIRE. EXPOSED WIRE SHALL BE MAX. 2" EACH SIDE

(2) TREE WRAP TO BE INSTALLED ONLY FROM OCTOBER 1 THROUGH APRIL 30. (DECIDUOUS 10) 6 FT. STEEL T-POST (SEE SCHEDULE). ALL SHALL BE

(3) PLANT TREE SO THAT FIRST ORDER MAJOR ROOT IS 1"-2" ABOVE FINAL GRADE.

(4) 3" DEEP MULCH RING PLACED A MINIMUM OF 4 FT. IN DIAMETER. DO NOT PLACE MULCH IN CONTACT WITH TREE TRUNK (FINISHED GRADE REFERENCES TOP OF MULCH).

5 1:1 SLOPE ON SIDES OF PLANTING PLACE ROOT BALL ON HOLE. SETTLEMENT.

6 REMOVE ALL TWINE, ROPE, BURLAP AND WIRE FROM ENTIRE ROOT BALL AND TRUNK

7 PLACE SOIL AROUND ROOT BALL FIRMLY, DO NOT COMPACT OR TAMP. SETTLE SOIL WITH WATER TO FILL ALL AIR POCKETS.

(9) GALVANIZED WIRE, MIN. 12

GAUGE CABLE - TWIST WIRE ONLY TO KEEP FROM SLIPPING.

DRIVEN OUTSIDE ROOTBALL AND IN UNDISTURBED SOIL. (11) 4-6" HIGH WATER SAUCER IN

NON-TURF AREAS. 12) BACKFILL WITH BLEND OF

EXISTING SOIL AND A MAXIMUM 20% (BY VOLUME) ORGANIC MATERIAL. WATER THOROUGHLY WHEN BACKFILLING

UNDISTURBED SOIL TO PREVENT

SCALE: 3/16" = 1'-0"

SHRUB PLANTING

1 SPECIFIED MULCH

2 AMENDED PLANTING BED TILLED TO A DEPTH OF 6"

SCALE: 1-1/2" = 1'-0"

(3) CENTER OF PLANT

WHEN PLANTED ON A CURVE ORIENT ROWS TO FOLLOW THE LONG AXIS OF AREAS WHERE PLANTS ARE MASSED

FENCING SHALL BE BY AMERISTAR FENCE - POOL PET PLAY MONTAGE PLUS OR APPROVED EQUAL

SCALE: 3/4" = 1'-0"

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Denver, Colorado 80204

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SHEET TITLE: LANDSCAPE **DETAILS** SHEET NUMBER:

L.03

SHEET 14 OF 15

Know what's below.

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PERENNIAL PLANT LAYOUT

SCALE: 1" = 1'-0"


POOL FENCE

CHECKED BY: DRAWN BY:

SHEET TITLE: LIGHTING PLAN

SHEET NUMBER: P.01 SHEET 15 OF 15

IMPACT E NGINEERING, INC.
554 Remington Place
Castle Rock, Colorado 80108
Phone: 303-873-6670 Cell: 303-877-9669
email: brian@impactengineeringinc.com

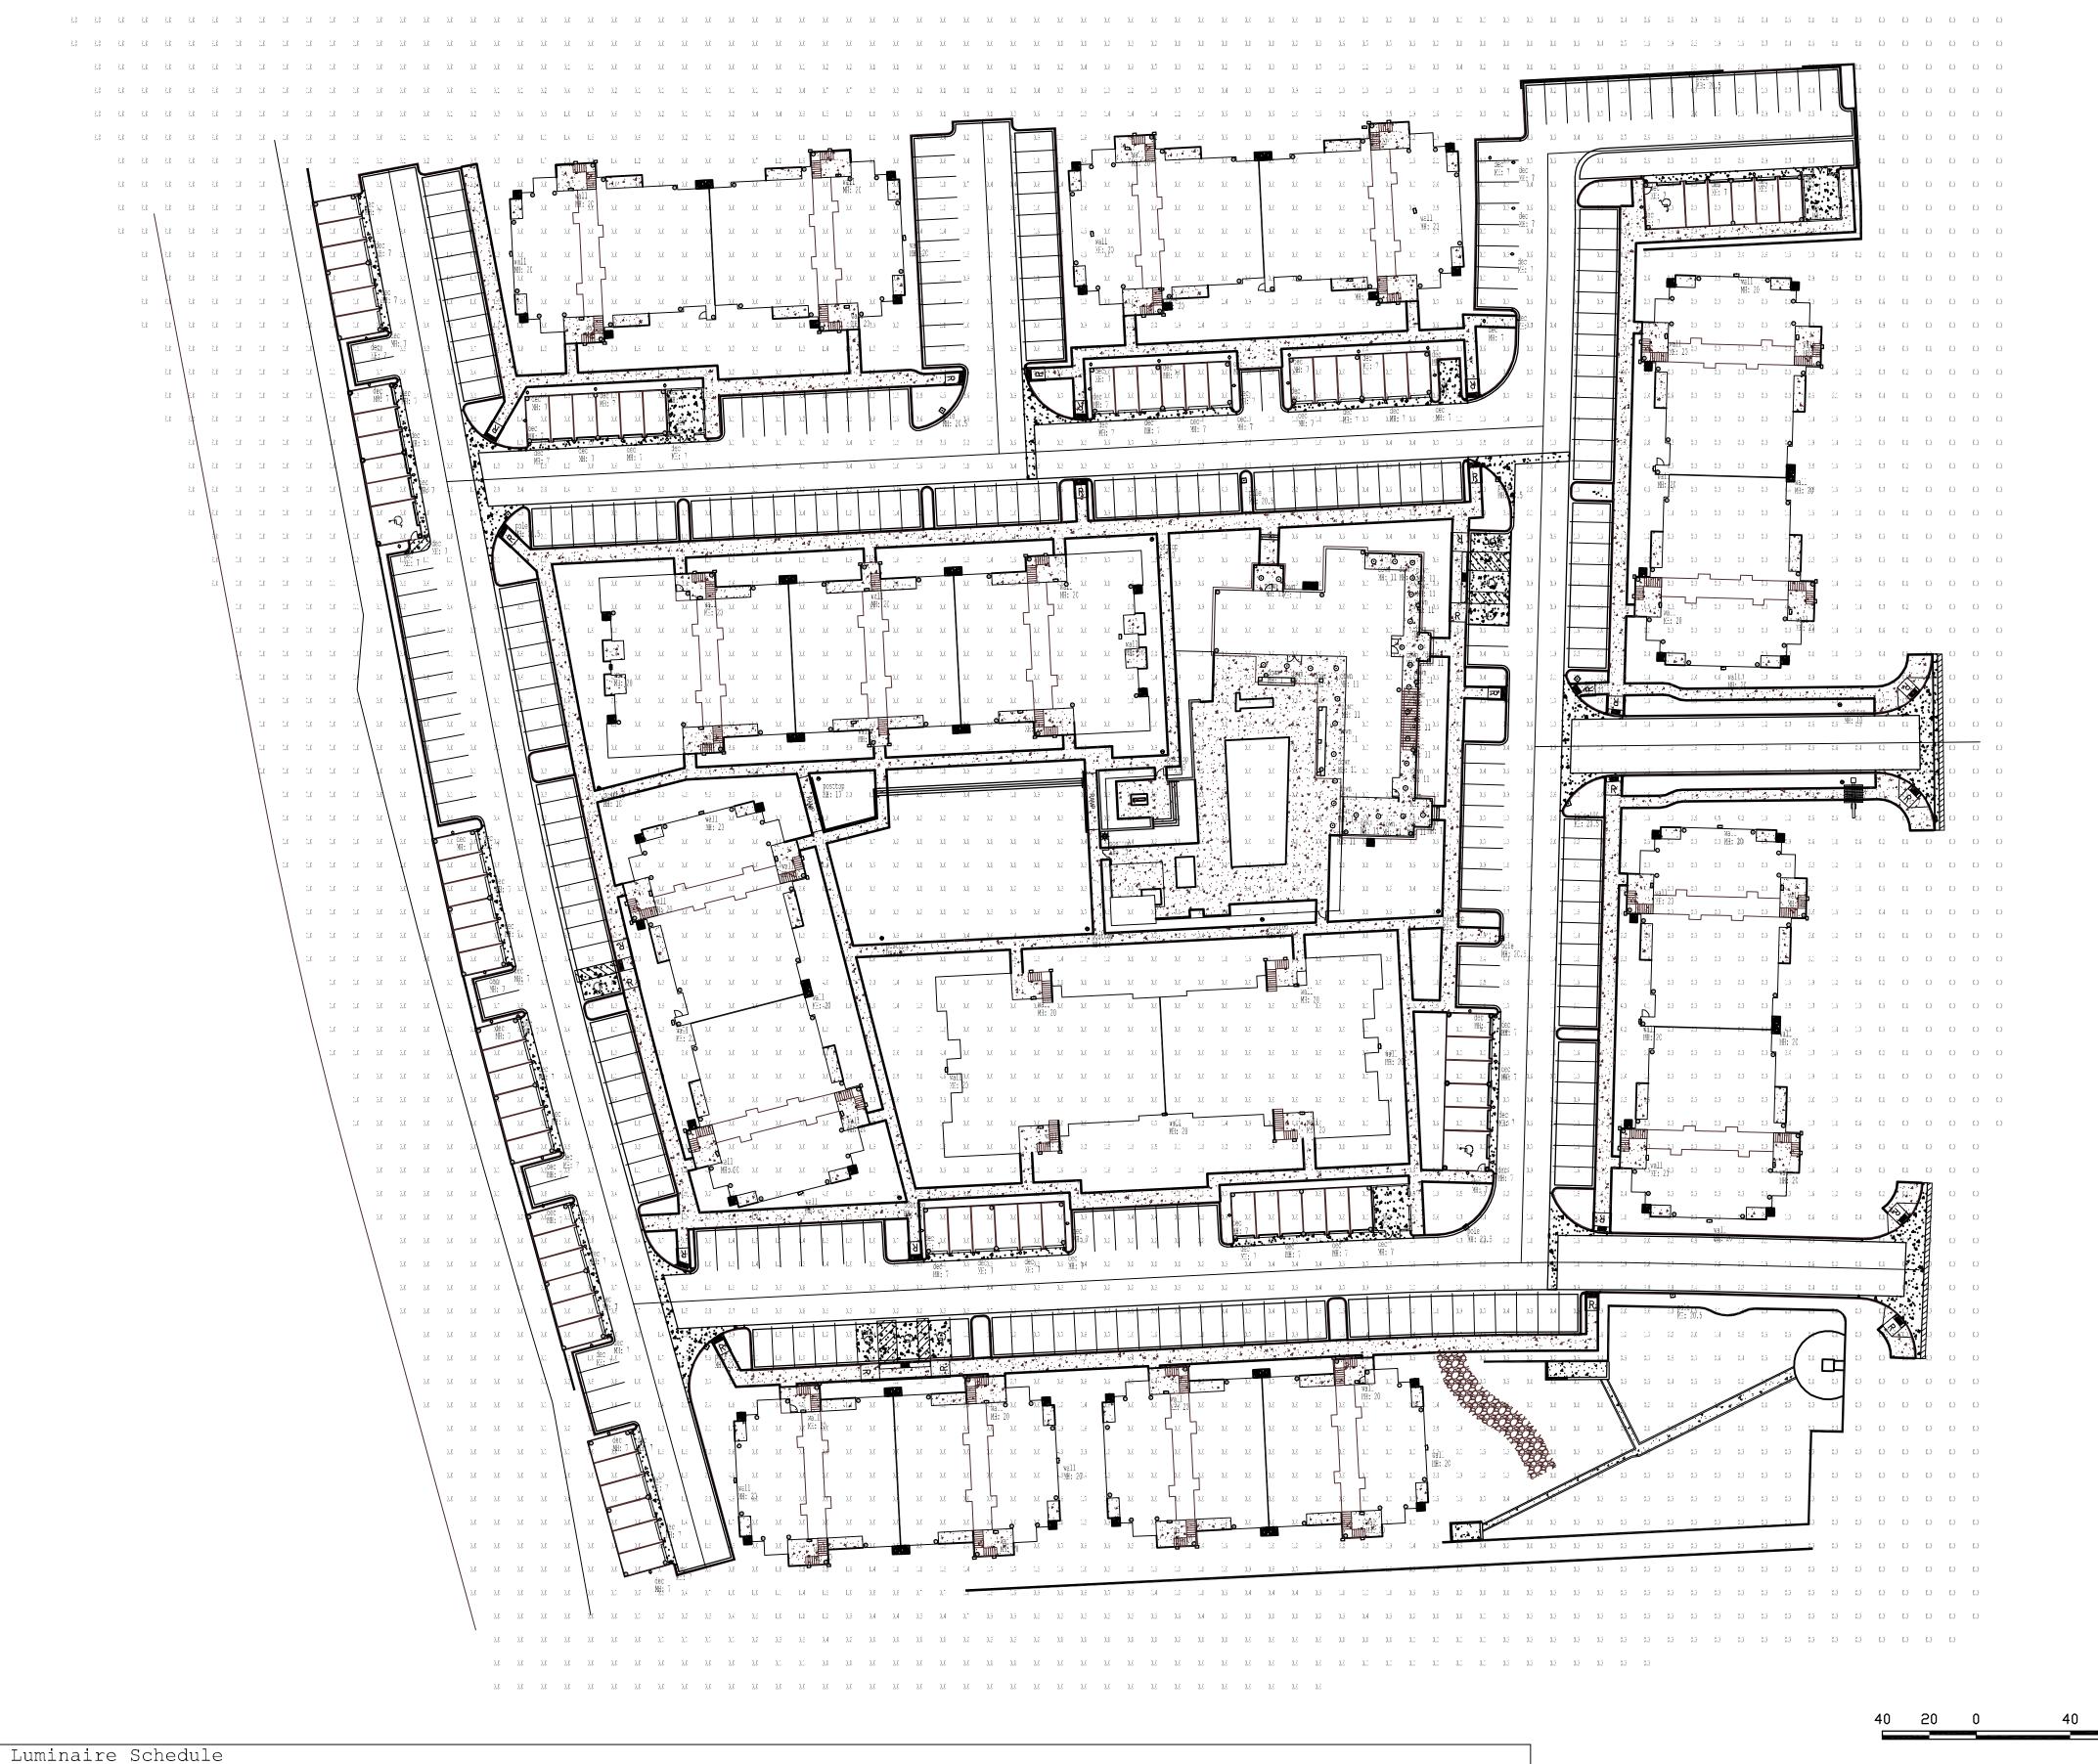

LLF

Lumens

600

600

12800

15000

1490

8500

Description

1.000 decorative entry light - 13w compact fluorescent

recessed downlight - 13w compact fluorescent

spaulding nite torch - type 5- 150w incandescant

lsi chalenger wall pack - forward throw - 175w metal halide

lsi citation pole mounted light - type 3 - 175 w metal halide

lsi citation pole mounted light - type 3 - 100 w metal halide

to to to to to to

SCALE: 1" = 40'

DESIGNATES FIXTURE IDENTIFIER

➤DENOTES MOUNTING HEIGHT OF FIXTURE

ŊŊ

Symbol

Label

down

wall

pole

posttop

pole-100

dec

Qty

92

30

62

12

CHECKED BY: DRAWN BY:



MEMORANDUM

To: City of Northglenn, Planning and Development

From: Steve Tuttle, P.E., PTOE

Date: March 4, 2013

Project: Stone Mountain Multi-Family Project

Subject: Parking Review and Recommendations

The Fox Tuttle Transportation Group has completed a review of the proposed parking for the Stone Mountain project in Northglenn. The project is proposing to construct 228 multi-family apartment units with a total of 342 parking spaces provided for residents and guests. Fox Tuttle reviewed both current industry parking practices with regards to the provision of multi-family and comparative rates from similar Front Range communities and found that the proposed parking supply is within the parking ratio ranges supported by this data. This memorandum summarizes our findings and recommendations.

Background

The Stone Mountain multi-family residential project is proposing to construct 228 apartment units on a vacant parcel of land located west of Community Center Drive north of Malley Drive. The project is surround by recreational-retail, institutional, and residential land uses. The project proposes the following types and number of units:

- 90 one-bedroom, studio units
- 48 one-bedroom units
- 72 two-bedroom units
- 18 three-bedroom units

The 342 parking spaces correspond to an effective parking rate of 1.5 parking spaces per dwelling unit for the 228 proposed units. In comparison, the approved PUD (Stone Mountain Apartments - Phase II Preliminary and Final Planned Unit Development, approved February 2000) referenced a 2.0 per unit rate but provided 1.77 on the PUD plans (332 spaces for 188 units). **Table 1** provides a comparison of the proposed parking to industry and peer rates, to be discussed in subsequent sections of this memorandum.

Industry Recommendations

Two leading industry parking resources were reviewed within the context of this project and are discussed in this memorandum:

- Institute of Transportation Engineers (ITE), Parking Generation, 4th Edition (2010)
- Urban Land Institute (ULI), <u>Shared Parking</u>, 2nd Edition (2005)

ITE publishes parking generation data for various land uses based on numerous studies and empirical data calculating average peak parking demand. For apartment land use, ITE provides both urban and suburban parking formulas to predict peak parking demand. The ITE suburban formulas were utilized for this analysis to provide the most conservative recommendations.

The ITE suburban apartment peak parking data is based on 19 studies at developments with an average of 320 dwelling units. The average size of the dwelling units for developments included in the study was 1.7 bedrooms per unit. In comparison, the Stone Mountain project proposes 228 units with a total of 336 bedrooms, or 1.47 bedrooms per unit. Thus, the ITE data can be considered slightly conservative given that the project has a lower bedroom ratio and would be expected to generate less peak parking demand.

The ITE methodology provides the following formula to calculate peak parking demand:

Peak Parking Demand = 1.42x - 38

where x equals the number of dwelling units

Using the ITE formula, the peak parking demand is anticipated to be 286 parking spaces. This corresponds to a rate of 1.25 spaces per unit and is 56 spaces (16%) less than is proposed for the Stone Mountain project.

The ULI book provides recommended parking calculations for various land uses based on a widely accepted methodology. The rates reviewed for this analysis and discussed in this section are the "base case" parking recommendations from which reductions are then applied to account for the effects of shared use. For multi-family residential rental use, ULI recommends a "base parking ratio" of 1.5 spaces per unit and a 15% guest parking ratio. These base rates are based on peak parking spaces required with "virtually 100% auto use and typical ridesharing for suburban conditions" and do not take into account any effect/reduction of shared parking for mixed use development. The ULI book further defines this rate as being applicable for a "cornfield project" that is a "free-standing land use in an area with little or no transit and only weak pedestrian connections with other uses". The Stone Mountain project is located 0.7 miles from the Wagon Road Park-n-Ride facility, will have a clubhouse and other amenities, and has excellent pedestrian connectivity with nearby retail and recreational uses. Thus, the base rates can be considered conservative as applied to this project.

As shown on Table 1, the recommended ULI rates correspond to a provision of 376 parking spaces for the project and an effective rate of 1.65 spaces per unit. The ULI data is attached, for reference. The proposed project parking provisions represent just under (34 spaces. or 9% short of) the recommended ULI provisions for high-auto-use conditions, as noted above.

Peer Review

Fox Tuttle conducted a peer review of nearby communities similar to Northglenn conditions to determine typical multi-family parking requirements.

The results of the peer review for the communities of Broomfield, Denver, and Boulder are summarized on Table 1. All three communities include guest parking provisions in their base rates. As shown on Table 1, using these communities' rates would result in project requirements of 282 to 351 parking spaces (1.24 to 1.54 spaces per unit). Most represent lower parking totals than are being proposed for the project.

Summary and Recommendations

The Stone Mountain multi-family residential project proposes to construct 228 apartment units with a provision of 342 parking spaces. Based on the review of industry standard parking practices and a peer review of other Front Range cities, it was determined that proposed parking provisions for the project are supported by this data. Given the results of this study, we recommend that the project request a deviation from the PUD to allow for a 1.5 space-per-unit parking ratio as supported by this data.

I hope that the contents of this memorandum are helpful to you. If you have any questions or would like to discuss our findings, please let me know.

/SGT

Attachments:

- Table 1 Multi-Family Parking Rate Comparison
- ULI Summary of Recommended Base Parking Ratios (Table 2-2)
- ITE Parking Generation for Apartment Land Use for Suburban Conditions

Multi-Family Parking Review and Recommendations



Multi-Family Parking Rate Comparison

Table 1a. Parking Ratios

	Proposed Units	Broomfield Code*	Denver Code**	Boulder Code***	ULI****	PROPOSED
Studio	90	1.0	1.25	1.0	1.5	
1-bed	48	1.5	1.25	1.0	1.5	1 F Avorago Patio
2-bed	72	2.0	1.25	1.5	1.5	1.5 Average Ratio
3-bed	18	2.5	1.25	2.0	1.5	
Guest Parking		Included in resident rate	Included in resident rate	Included in resident rate	15% x # of units	Included in resident rate

^{*}Based on standard parking code for muti-family

Table 1b. Parking Spaces

	Proposed Units	ITE Suburban ⁽¹⁾	Broomfield	Denver	Boulder	ULI	Proposed
Studio	90 units	Based on Peak Demand Studies Peak Parking Demand = 1.42 x Units - 38	90 spaces	113 spaces	90 spaces	135 spaces	
1-bed	48 units		72 spaces	60 spaces	48 spaces	72 spaces	
2-bed	72 units		144 spaces	90 spaces	108 spaces	108 spaces	Average 1.5 spaces per unit
3-bed	18 units		45 spaces	23 spaces	36 spaces	27 spaces	dine
Total Resident Parking	342 spaces		351 spaces	285 spaces	282 spaces	342 spaces	
Total Guest Parking	Included in resident total		Included in resident total	Included in resident total	Included in resident total	34 spaces	Included in resident total
Total	342 spaces	286 spaces	351 spaces	285 spaces	282 spaces	376 spaces	342 spaces
Parking Rates	·	1.25	1.54	1.25	1.24	1.65	1.50

⁽¹⁾ Institute of Transportation Engineers, Parking Generation, 4th Edition, 2010.

^{**}Requirement based on new zoning code and Suburban Neighborhood Context Group with Multi-unit Dwelling only on site (Suburban near Commercial Corridor up to 5 stories)

^{***} Assumes RM district (residential medium) for a stand alone multi-family project. This is the same as the MXD code (RMX)

^{****} Urban Land Institute, Shared Parking 2nd Edition, 2005.

Table 2-2 Summary of Recommended Base Parking Ratios (Spaces per Unit Land Use)

Land Use	Weekday		Weekend		Unit	Source
	Visitor	Employee	Visitor	Employee		
Community Shopping Center (<400,000 sq. ft.)	2.9	0.7	3.2	0.8	/ksf1GLA	1
Regional Shopping Center (400,000 to 600,000 sq. ft.)	Sliding scale	e between 400,000	and 600,000 s	q. ft.	/ksf GLA	1
Super Regional Shopping Center (>600,000 sq. ft.)	3.2	0.8	3.6	0.9	/ksf GLA	1
Fine/Casual Dining	15.25	2.75	17.0	3.0	/ksf GLA	2,3
Family Restaurant	9.0	1.5	12.75	2.25	/ksf GLA	3
Fast-Food Restaurant	12.75	2.25	12.0	2.0	/ksf GLA	2
Nightclub	15.25	1.25	17.5	1.5	/ksf GLA	3
Active Entertainment	Custom to e	each tenant				
Cineplex	0.19	0.01	0.26	0.01	/seat	3, 2
Performing Arts Theater	0.3	0.07	0.33	0.07	/seat	2
Arena	0.27	0.03	0.3	0.03	/seat	3
Pro Football Stadium	0.3	0.01	0.3	0.01	/seat	3
Pro Baseball Stadium	0.31	0.01	0.34	0.01	/seat	3
Health Club	6.6	0.4	5.5	0.25	/ksf GFA	3, 4
Convention Center	5.5	0.5	5.5	0.5	/ksf GLA	3
Hotel—Business	1.0	0.25	0.9	0.18	/room	2,3
Hotel—Leisure	0.9	0.25	1.0	0.18	/room	2,3
Restaurant/Lounge	10.0		10.0	_	/ksf GLA	2, 3, 5
Conference Center/Banquet (20 to 50 sq. ft./guest room)	30.0	_	30.0	_	/ksf GLA	2, 3, 5
Convention Space (>50 sq. ft./guest room)	20.0		10.0	_	/ksf GLA	2, 3, 5
Residential, Rental	0.15	1.5 ²	0.15	1.5 ²	/unit	2
Residential, Owned	0.15	1.72	0.15	1.72	/unit	2
Office (<25,000 sq. ft.)	0.3	3.5	0.03	0.35	/ksf GFA	2
Office (25,000 to 100,000 sq. ft.) Sliding scale between					/ksf GFA	2
25,000 sq. ft.:	0.3	3.5	0.03	0.35		
100,000 sq. ft.:	0.25	3.15	0.03	0.32		
Office (100,000 to 500,000 sq. ft.) Sliding scale between					/ksf GFA	2
100,000 sq. ft.:	0.25	3.15	0.03	0.32		
500,000 sq. ft.:	0.2	2.6	0.02	0.26		
Office >500,000 sq. ft.	0.2	2.6	0.02	0.26	/ksf GFA	2
Data Processing Office	0.25	5.75	0.03	0.58	/ksf GFA	2,3
Medical/Dental Office	3.0	1.5	3.0	1.5	/ksf GFA	2,3
Bank, Branch with Drive-in	3.0	1.6	3.0	1.6	/ksf GFA	2

Ratios based on peak parking spaces required with virtually 100% auto use and typical ridesharing for suburban conditions. 1/ksf = per thousand sq. ft.

- 1. Parking Requirements for Shopping Centers, 2nd ed. (Washington, D.C.: ULI-the Urban Land Institute, 1999).
 2. Parking Generation, 3rd ed. (Washington, D.C.: Institute of Transportation Engineers, 2004).
 3. Data collected by team members.
 4. John W. Dorsett, "Parking Requirements for Health Clubs," The Parking Professional, April 2004.
 5. Gerald Salzman, "Hotel Parking: How Much Is Enough?" Urban Land, January 1988.

²1.0 spaces reserved for residents' sole use, 24 hours a day, remainder shared with visitors and other uses.

Land Use: 221 Low/Mid-Rise Apartment

Average Peak Period Parking Demand vs. Dwelling Units On a: Weekday Location: Suburban

Statistic	Peak Period Demand				
Peak Period	12:00–5:00 a.m.				
Number of Study Sites	Market of all Lativeren 21 and object or micro				
Average Size of Study Sites	311 dwelling units				
Average Peak Period Parking Demand	1.23 vehicles per dwelling unit				
Standard Deviation	0.32 military from				
Coefficient of Variation	21% 1999/10 1995/10				
95% Confidence Interval	1.10-1.37 vehicles per dwelling unit				
Range	0.59-1.94 vehicles per dwelling unit				
85th Percentile	1.94 vehicles per dwelling unit				
33rd Percentile	0.68 vehicles per dwelling unit				

